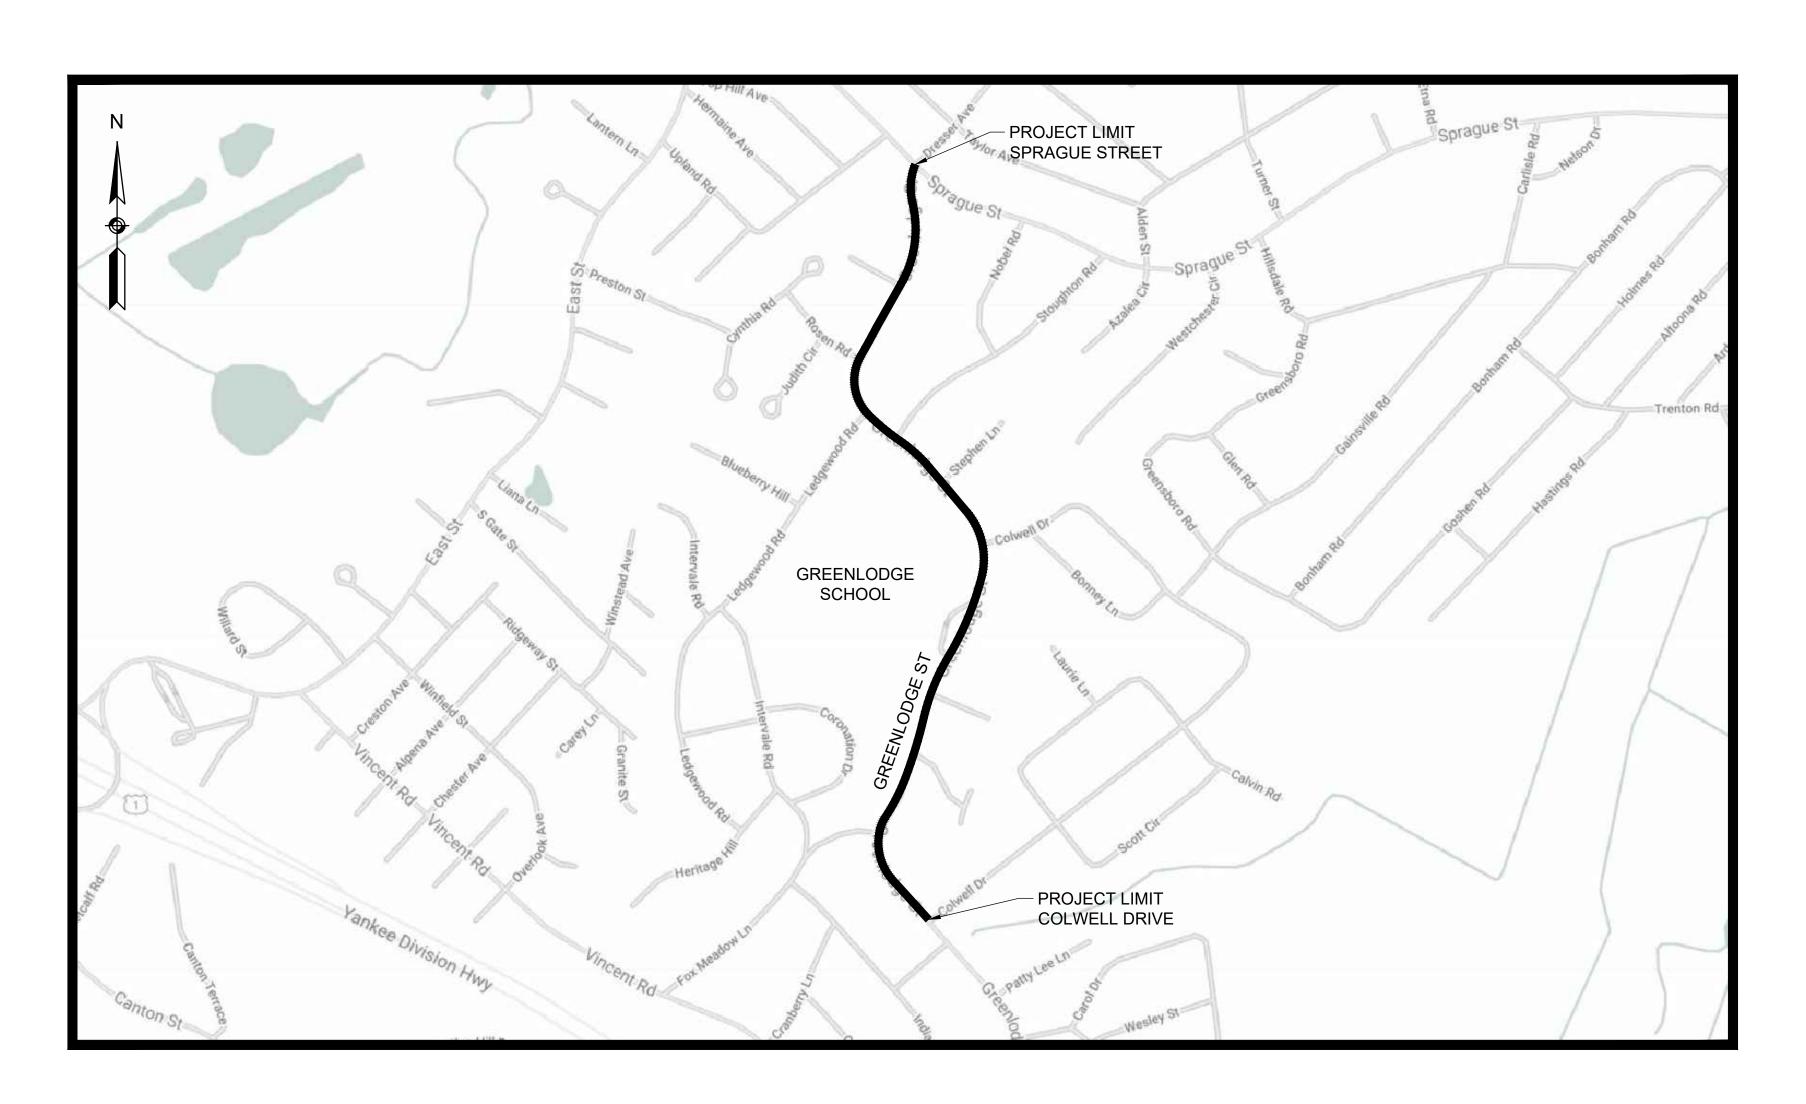
GREENLODGE STREET CORRIDOR IMPROVEMENTS

IN THE TOWN OF DEDHAM, MASSACHUSETTS



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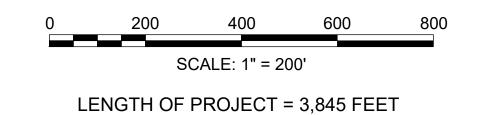
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SHEET NO. DESCRIPTION



FINAL SUBMITTAL



99 SUMMER STREET SUITE 700 BOSTON, MASSACHUSETTS 02110 (617) 695-3400

TOWN OF DEDHAM MASSACHUSETTS

PROJECT TITLE

(617) 695-3310

GREENLODGE STREET CORRIDOR IMPROVEMENTS

SEAL

0 8/2022 FINAL

No. DATE BY Description

REVISIONS

DESIGNED BY: ___

SHEET TITLE

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PROJECT NO. 50141766

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SHEET NO. 1 OF 33

D

TYPICAL

TYP

ADJ	ADJUST
ВО	BY OTHERS
BOS	BOTTOM OF SLOPE
CW	CROSSWALK
DYCL	DOUBLE YELLOW CENTERLINE
EX	EXISTING
PC	POINT OF CURVATURE
PCR	PEDESTRIAN CURB RAMP
PR	PROPOSED
PT	POINT OF TANGENCY
R&R	REMOVE & RESET
REM	REMOVE
RET	RETAIN
SL	STOP LINE (24" WIDE RETROREFLECTIVE WHITE LINE)
SWEL	SOLID WHITE EDGE LINE (6" WIDE RETROREFLECTIVE WHITE LINE)
TOS	TOP OF SLOPE

GENERAL NOTES:

- 1. IT WILL BE THE CONTRACTOR'S RESPONSIBILITY TO VERIFY EXISTING GRADES AND ELEVATIONS AT THE LOCATIONS WHERE PROPOSED WORK MEETS EXISTING CONDITIONS.
- 2. IT WILL BE THE CONTRACTOR'S RESPONSIBILITY TO MAKE THEIR OWN DETERMINATION OF SUBSURFACE CONDITIONS INCLUDING THE LOCATION OF ROCK AND THE ACTUAL LOCATION OF UTILITIES OR OTHER FEATURES WHICH MAY AFFECT CONSTRUCTION.
- 3. THE RELOCATION, INSTALLATION, OR REMOVAL OF PRIVATE UTILITIES SHALL BE ACCOMPLISHED BY THEIR OWNERS, EXCEPT AS OTHERWISE NOTED. THE CONTRACTOR WILL BE REQUIRED TO COOPERATE WITH THE PRIVATE UTILITY COMPANIES AND ALLOW THEM ADEQUATE TIME TO COMPLETE THEIR WORK IN ADVANCE OF PERFORMING ANY PAVING OPERATIONS OR OTHER FINISHED WORK.
- 4. AREAS OUTSIDE OF THE LIMITS OF THE PROPOSED WORK DISTURBED BY THE CONTRACTOR'S OPERATIONS SHALL BE RESTORED BY THE CONTRACTOR AT THE CONTRACTOR'S EXPENSE TO THEIR ORIGINAL CONDITION AND TO THE SATISFACTION OF THE ENGINEER.
- 5. THE CONTRACTOR SHALL CONTACT "DIG SAFE" AT 1-888-DIG SAFE AT LEAST 72 HOURS PRIOR TO COMMENCING WORK ON THE PROJECT.
- 6. BEFORE CONSTRUCTION, ALL UTILITIES (PRIVATE & PUBLIC) MUST BE NOTIFIED (SEE MASSACHUSETTS GENERAL LAWS, CH 82, SEC 40).
- 7. THE CONTRACTOR WILL BE RESPONSIBLE FOR PROVIDING AND FOR MAINTAINING ALL EROSION CONTROL MEASURES THROUGHOUT THE DURATION OF THE CONTRACT AT AREAS WHERE SHOWN ON THE PLANS AND DIRECTED BY THE ENGINEER.
- 8. THE CONTRACTOR SHALL COMPLY WITH ALL APPLICABLE FEDERAL, STATE, AND LOCAL SAFETY CODES AND LEGAL REQUIREMENTS IN THE CONSTRUCTION OF IMPROVEMENTS.
- 9. ALL EXISTING PIPING AND STRUCTURES EXPOSED DURING EXCAVATION SHALL BE ADEQUATELY SUPPORTED, BRACED, OR OTHERWISE PROTECTED DURING CONSTRUCTION ACTIVITIES. EXCAVATIONS SHALL BE BACKFILLED DAILY AT THE COMPLETION OF WORK.
- 10. UNLESS OTHERWISE NOTED OR APPROVED BY THE ENGINEER, THE CONTRACTOR SHALL MAINTAIN ALL EXISTING UTILITIES IN SERVICE AT ALL TIMES. IF THE CONTRACTOR DAMAGES UTILITY SYSTEMS, THEY SHALL IMMEDIATELY NOTIFY THE RESPECTIVE UTILITY COMPANY AND SHALL REPAIR/REPLACE THE AFFECTED SYSTEM AT THEIR OWN EXPENSE.
- 11. ALL MATERIALS TO BE REMOVED AND DISCARDED SHALL BE DISPOSED OF IN ACCORDANCE WITH ALL APPLICABLE CODES AND REGULATIONS.
- 12. CONTRACTOR SHALL PROVIDE ADEQUATE BRACING AND SHORING OF ALL EXCAVATIONS IN ACCORDANCE WITH THE REQUIREMENTS OF APPLICABLE CODES AND REGULATIONS.
- 13. THE TEMPORARY TRAFFIC CONTROL PLAN INDICATES THE GENERAL REQUIREMENTS FOR THE VARIOUS PHASES OF WORK. THE CONTRACTOR SHALL SUBMIT DETAILED TRAFFIC MANAGEMENT PLANS TO THE ENGINEER FOR APPROVAL.
- 14. THE FLOW OF TRAFFIC AROUND THE SITE MUST BE MAINTAINED AS SHOWN ON THE TRAFFIC CONTROL PLANS AND SPECIFIED IN THE SPECIAL PROVISIONS. CONSTRUCTION EQUIPMENT AND MATERIALS SHALL NOT BE PARKED OR STOCKPILED SO AS TO OBSTRUCT THE FLOW OF VEHICLES.

DRAINAGE NOTES:

- 1. NO EXISTING DRAINAGE SYSTEMS SHALL BE ABANDONED, PLUGGED, OR REMOVED WITHOUT PRIOR APPROVAL OF THE ENGINEER.
- 2. ALL CATCH BASIN RIM ELEVATIONS ARE GIVEN AT THE CENTER OF BACK OF THE GRATE, CATCH BASIN GRATES SHALL BE FLUSH WITH THE ROADWAY FINISHED GRADE.
- 3. CASTINGS ON STRUCTURES DESIGNATED TO BE REMOVED AND DISPOSED SHALL BE INSPECTED BY THE ENGINEER PRIOR TO REMOVAL. CASTINGS JUDGED TO BE SATISFACTORY FOR REUSE SHALL BE REUSED AT OTHER LOCATIONS WITHIN THE PROJECT OR STACKED FOR COLLECTION BY THE OWNER. CASTINGS JUDGED TO BE UNSATISFACTORY SHALL BECOME THE PROPERTY OF THE CONTRACTOR AND SHALL BE DISPOSED OF



99 SUMMER STREET SUITE 700

BOSTON, MASSACHUSETTS 02110 (617) 695-3400 (617) 695-3310

TOWN OF DEDHAM MASSACHUSETTS

PROJECT TITLE

GREENLODGE STREET CORRIDOR **IMPROVEMENTS**

SEAL

0 8/2022 FINAL No. DATE BY Description REVISIONS SCA

DESIGNED BY: CHECKED BY:

DATE:

SHEET TITLE

GENERAL NOTES. ABBREVIATIONS, & LEGEND

PROJECT NO. 50141766

G - 2

SHEET NO. 2 OF 33

SURVEY NOTES:

- 1. THE TOPOGRAPHY, SURFACE IMPROVEMENTS AND SITE DETAIL DEPICTED HEREON WAS OBTAINED FROM AN ON-THE-GROUND INSTRUMENT SURVEY CONDUCTED BY BRENNAN CONSULTING, INC. BETWEEN JULY 9-AUGUST 14, 2021.
- 2. THE HORIZONTAL DATUM IS BASED ON THE NORTH AMERICAN DATUM OF 1983 (NAD83), BASED ON GPS OBSERVATIONS.
- 3. THE VERTICAL DATUM IS BASED ON THE NORTH AMERICAN VERTICAL DATUM OF 1988 (NAVD88), BASED ON GPS OBSERVATIONS.
- 4. UTILITY INFORMATION SHOWN IS BASED ON BOTH A FIELD SURVEY AND PLANS OF RECORD. THE LOCATIONS OF UNDERGROUND PIPES AND CONDUITS HAVE BEEN DETERMINED FROM THE AFOREMENTIONED RECORD PLANS AND ARE APPROXIMATE ONLY. WE CANNOT ASSUME RESPONSIBILITY FOR DAMAGES INCURRED AS A RESULT OF UTILITIES THAT ARE OMITTED OR INACCURATELY SHOWN ON SAID RECORD PLANS, SINCE SUBSURFACE UTILITIES CANNOT BE VISIBLY VERIFIED. BEFORE PLANNING FUTURE CONNECTIONS, THE PROPER UTILITY ENGINEERING DEPARTMENT SHOULD BE CONSULTED AND THE ACTUAL LOCATION OF SUBSURFACE STRUCTURES SHOULD BE DETERMINED IN THE FIELD. CALL, TOLL FREE, THE DIG SAFE CALL CENTER AT 811 SEVENTY-TWO HOURS PRIOR TO EXCAVATION.
- 5. TEMPORARY BENCH MARKS SET:

BREN-1: SPIKE IN UTILITY POLE.	ELEV=67.44
BREN-2: X-CUT ON HYDRANT.	ELEV=73.95
BREN-3: SPIKE IN UTILITY POLE #26/25.	ELEV=90.74
BREN-4: X-CUT ON HYDRANT.	ELEV=118.7
BREN-5: X-CUT ON HYDRANT.	ELEV=123.9
BREN-6: X-CUT ON HYDRANT.	ELEV=147.
BREN-7: SPIKE IN UTILITY POLE #5.	ELEV=143.
BREN-8: X-CUT ON HYDRANT.	ELEV=151.0

		CL O	F GREENLO	DOGE ST CONSTRUCTIO	N BASELINE	DATA		
NUMBER	STARTING STATION	NORTHING	EASTING	CURVE DATA	LINE DATA	ENDING STATION	NORTHING	EASTING
L2	10+00.00	2905645.190	749458.597		N41°58'13"W 384.36'	13+84.36	2905930.956	749201.560
C1	13+84.36	2905930.956	749201.560	R=200.00 [°] Δ=74°32'49" L=260.22' T=152.21'		16+44.57	2906172.390	749181.72
L3	16+44.57	2906172.390	749181.723		N32°34'36"E 49.35'	16+93.92	2906213.972	749208.29
C2	16+93.92	2906213.972	749208.292	R=700.00 [°] Δ= 18°34'15" L=226.88' T=114.45'		19+20.80	2906421.457	749297.61
L4	19+20.80	2906421.457	749297.611		N14°00'21"E 193.61'	21+14.42	2906609.312	749344.46
C3	21+14.42	2906609.312	749344.468	R=1115.00 [°] Δ= 13°15'26" L=257.99' T=129.58'		23+72.41	2906850.216	749435.18
L5	23+72.41	2906850.216	749435.183		N27°15'47"E 147.03'	25+19.44	2906980.913	749502.53
C4	25+19.44	2906980.913	749502.535	R=700.00 [°] Δ= 3°08'52" L=38.46' T=19.23'		25+57.90	2907015.566	749519.20
L6	25+57.90	2907015.566	749519.204		N24°06'55"E 130.94'	26+88.83	2907135.075	749572.70

		CL OF	FOX MEADO	OW LANE CONSTRUCTION	ON BASELIN	E DATA		
NUMBER	STARTING STATION	NORTHING	EASTING	CURVE DATA	LINE DATA	ENDING STATION	NORTHING	EASTING
L13	70+00.00	2906142.732	749013.729		N86°40'37"E 61.13'	70+61.13	2906146.276	749074.756
C10	70+61.13	2906146.276	749074.756	R=183.90 Δ=27°41'23" L=88.87' T=45.32'		71+50.00	2906130.204	749161.287




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TOWN OF DEDHAM MASSACHUSETTS

PROJECT TITLE

GREENLODGE STREET CORRIDOR **IMPROVEMENTS**

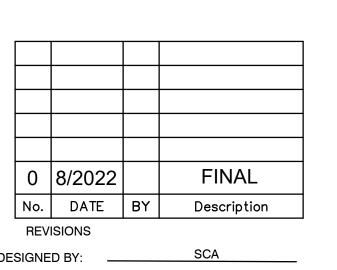SEAL



SHEET TITLE

CHECKED BY:

SURVEY CONTROL PLAN (SHEET 1 OF 2)

PROJECT NO.

SHEET NO. 3 OF 33

c	
	BEGIN FOX MEADOW LANE ALIGNMENT STA 70+00 N2906142.7320 E749013.7286 S72° 35' 38.79"W 83.56
	N: 2906131.1501 E:749085.6215 Z:73.99 MNS
	TBM BREN @TOP NAIL TO See The second
	OLIPF 71+50— CO 76 PT +44.57
	O IPF GREENLODGE ST STA 15+97.59 = S24° 46' 10 88"F
В	1 FOX MEADOW LANE STA 71+50 4 N:2905718.1495 FE:749366.3342 FE:749366.3342 FOX MEADOW LANE ALIGNMENT FOX MEADOW LANE ALIGN
	E749161.2871
	$ \begin{array}{c ccccccccccccccccccccccccccccccccccc$
	N51° 39′ 49.96″W 117.62 N86° 51′ 59.52″E 25.43 N:2906370.8715 E:749301.0893 Z:72.25 MNS MNS
	\Box SB \bigcirc
	BEGIN GREENLODGE ST ALIGNMENT STA 10+00 N2905645.1903 PC +19.44 MNS R2907072.2314 BEGIN GREENLODGE ST ALIGNMENT STA 10+00 N2905645.1903
A	C ₄ E:749585.9885 Z:114.48 MNS
	PT +57.90 —
	0 60 100 200 300 SCALE: 1" = 60'

		CL OF S	PRAGUE S1	Γ CONSTRUCT	ΓΙΟΝ BASELI	NE DATA		
NUMBER	STARTING STATION	NORTHING	EASTING	CURVE DATA	LINE DATA	ENDING STATION	NORTHING	EASTING
L11	100+00.00	2909203.437	749218.230		S44°23'29"E 300.00'	103+00.00	2908989.065	749428.096

		CL OF C	OLWELL DR	CONSTRUCT	ION BASELI	NE DATA		
NUMBER	STARTING STATION	NORTHING	EASTING	CURVE DATA	LINE DATA	ENDING STATION	NORTHING	EASTING
L12	80+00.00	2907416.662	749599.160		N74°17'07"E 150.00'	81+50.00	2907457.289	749743.554

D

		CL OF	GREENLO	DGE ST CONSTRUCTIO	N BASELINE	DATA		
NUMBER	STARTING STATION	NORTHING	EASTING	CURVE DATA	LINE DATA	ENDING STATION	NORTHING	EASTING
C5	26+88.83	2907135.075	749572.701	R=440.00 [°] Δ=62°14'27" L=477.98' T=265.64'		31+66.81	2907586.498	749517.232
L7	31+66.81	2907586.498	749517.232		N38°07'32"W 216.03'	33+82.84	2907756.443	749383.855
C6	33+82.84	2907756.443	749383.855	R=500.00 [°] Δ=20°25'07" L=178.18' T=90.05'		35+61.03	2907874.270	749251.446
L8	35+61.03	2907874.270	749251.446		N58°32'39"W 114.84'	36+75.87	2907934.197	749153.485
C7	36+75.87	2907934.197	749153.485	R=235.00 [°] Δ=86°59'00" L=356.76' T=222.94'		40+32.63	2908246.575	749069.477
L9	40+32.63	2908246.575	749069.477		N28°26'21"E 352.97'	43+85.61	2908556.954	749237.572
C8	43+85.61	2908556.954	749237.572	R=515.00 [°] Δ=36°04'19" L=324.23' T=167.69'		47+09.84	2908870.616	749295.158
L10	47+09.84	2908870.616	749295.158		N7°37'58"W 119.12'	48+28.96	2908988.684	749279.335
C9	48+28.96	2908988.684	749279.335	R=112.54 [°] Δ=61°37'22" L=121.04' T=67.12'		49+50.00	2909094.668	749324.713




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TOWN OF DEDHAM MASSACHUSETTS

PROJECT TITLE

GREENLODGE STREET CORRIDOR IMPROVEMENTS

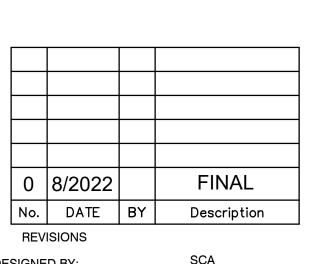SEAL



DESIGNED BY: SCA

CHECKED BY: APZ

DATE: 08/2022

SHEET TITLE

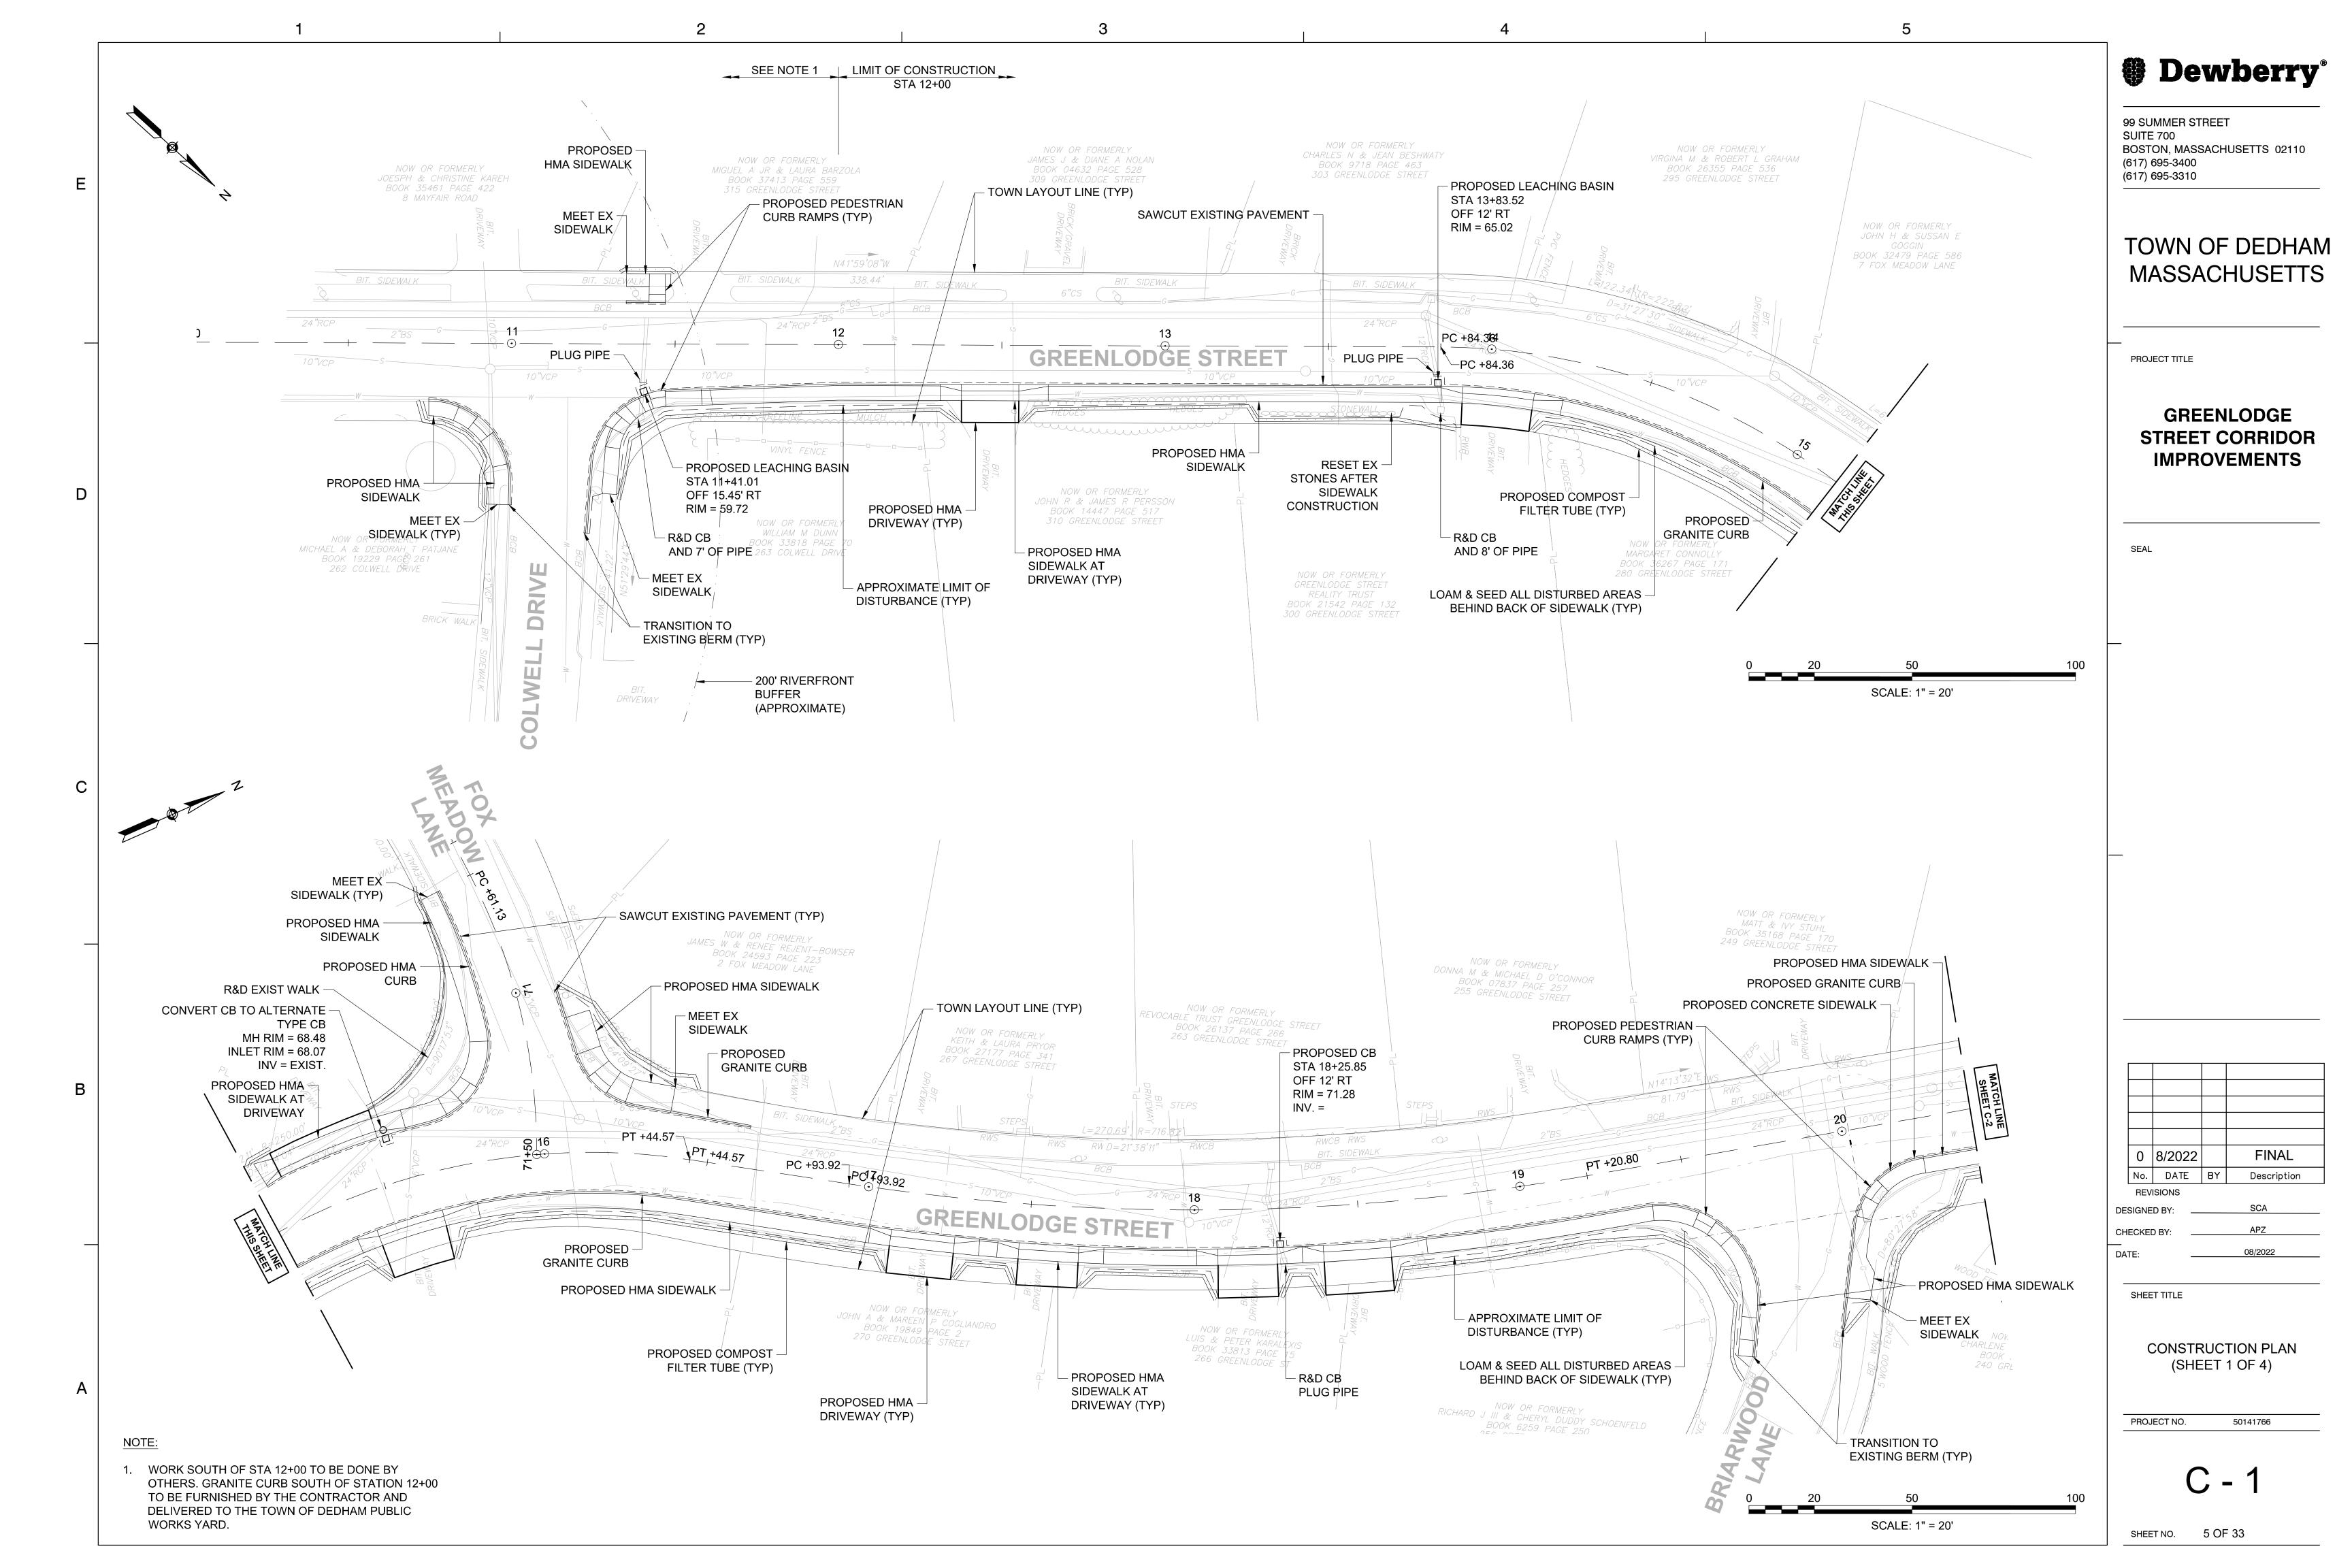
SURVEY CONTROL PLAN (SHEET 2 OF 2)

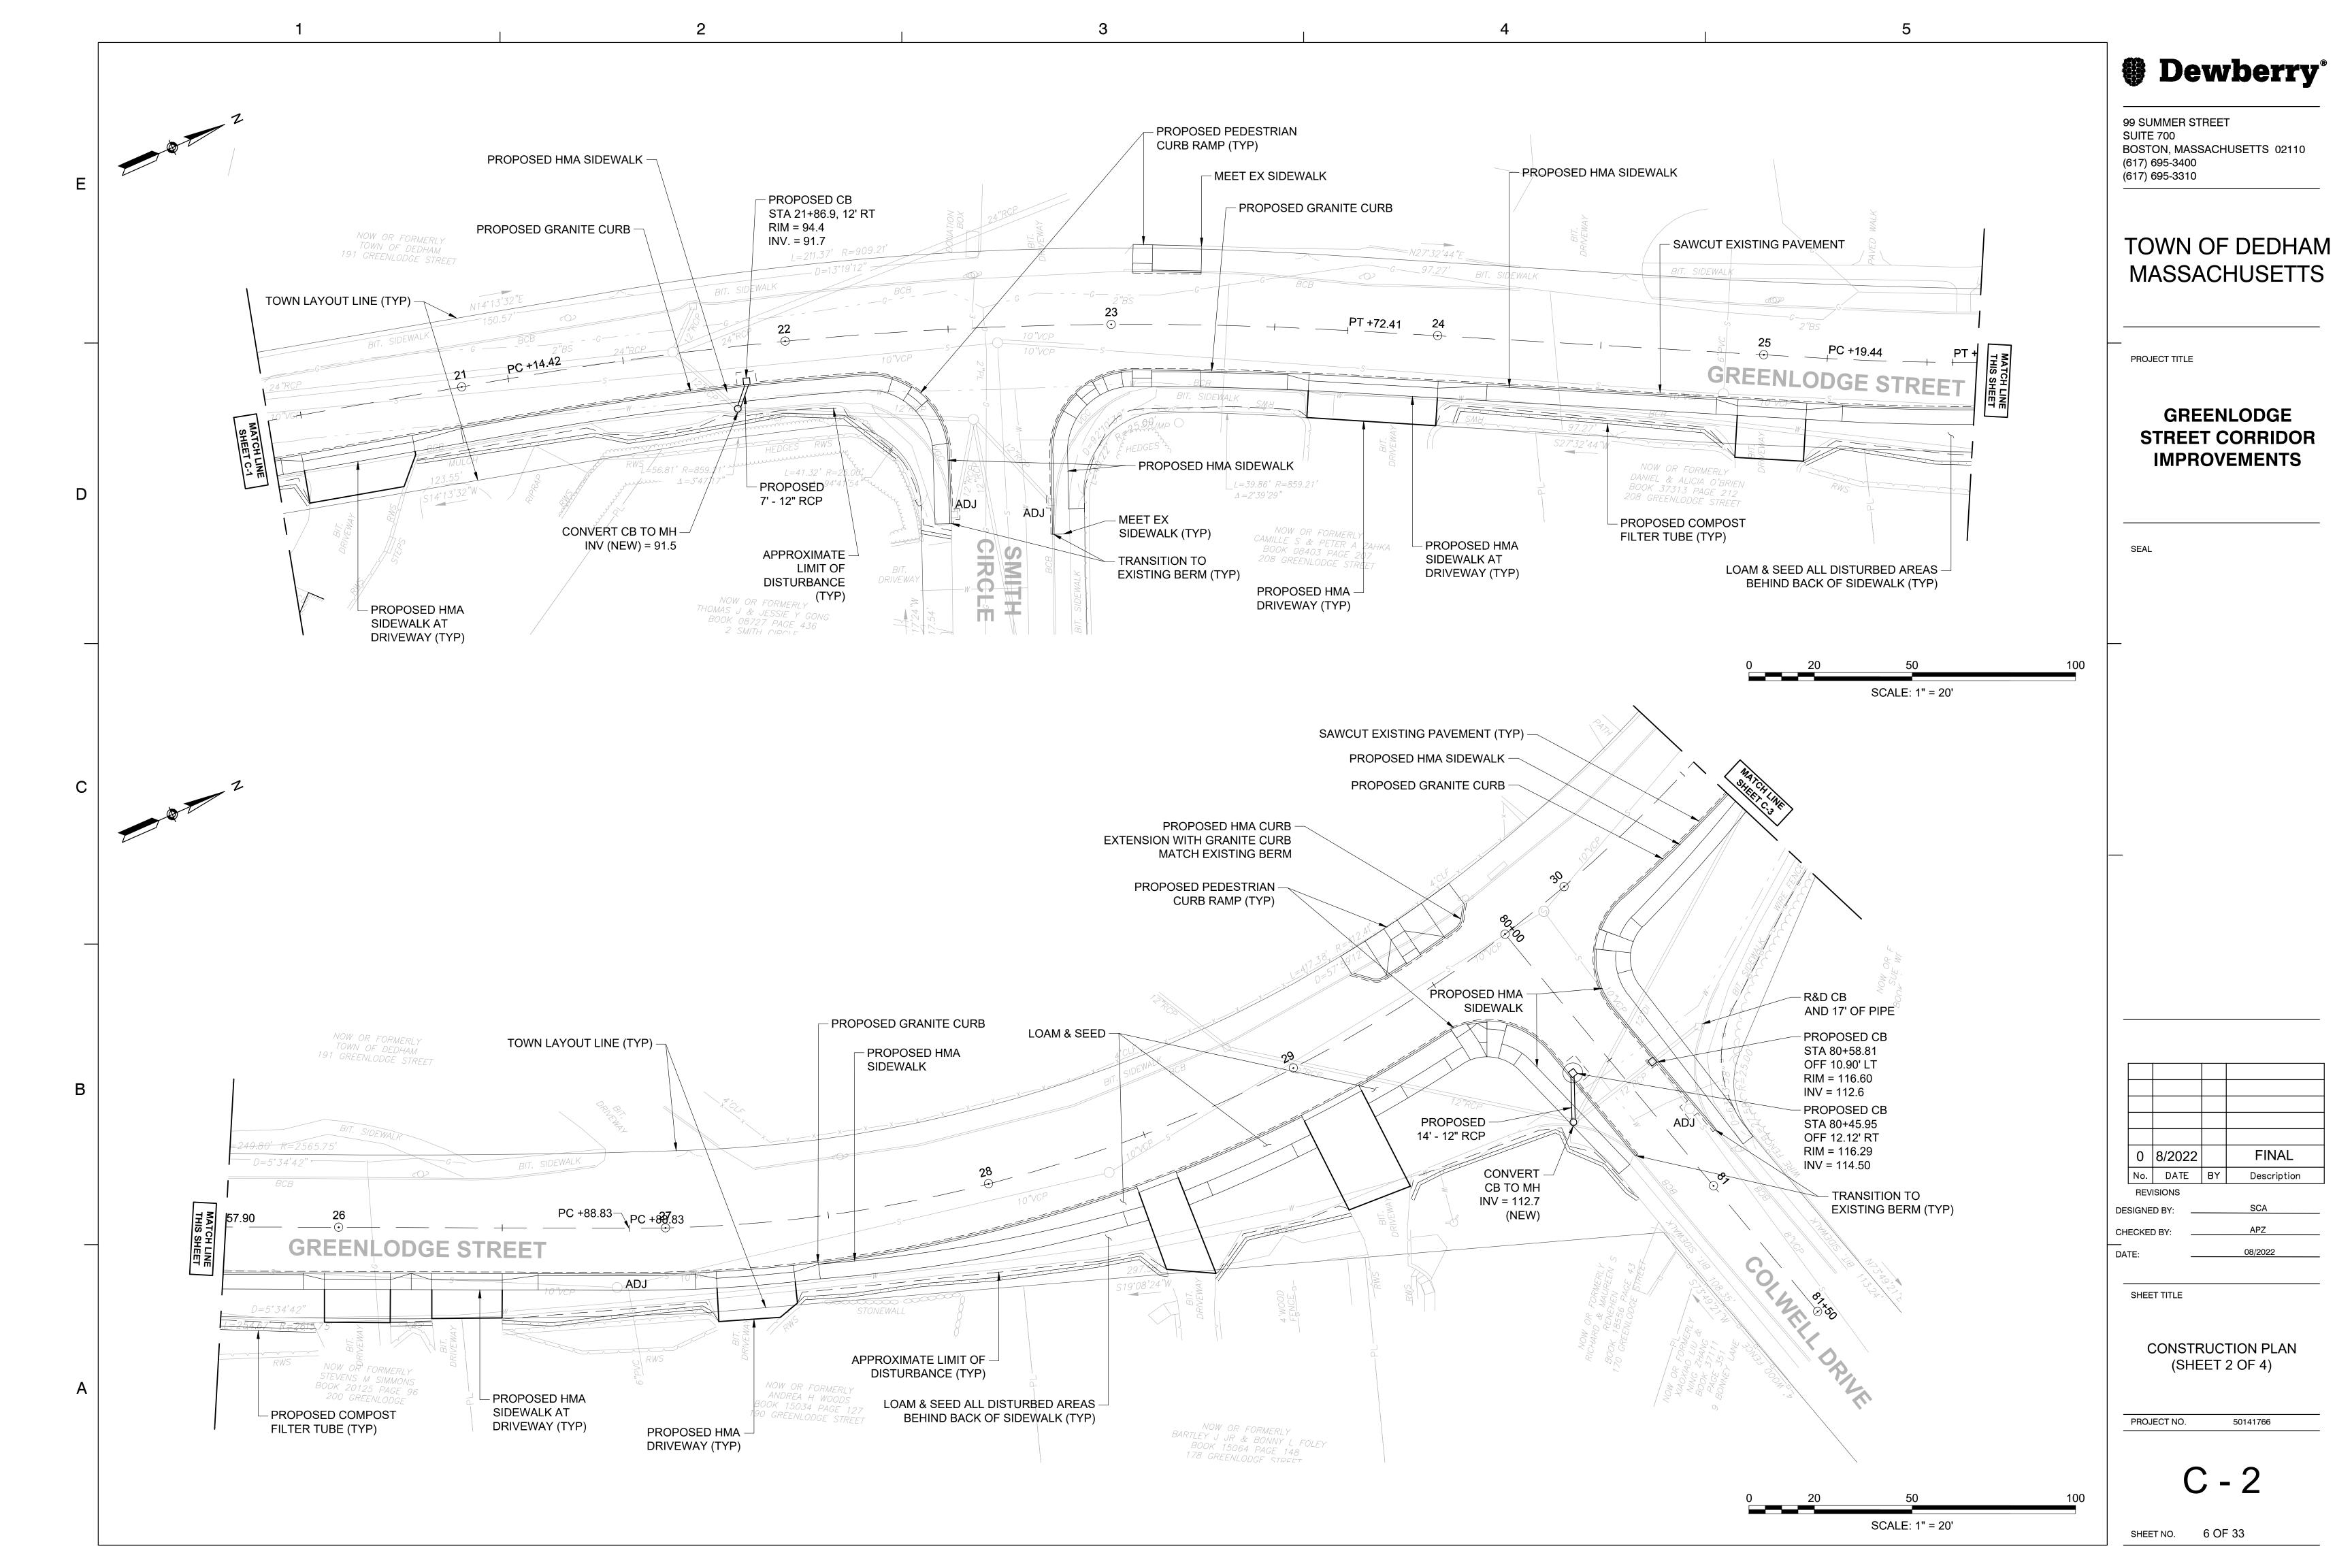
PROJECT NO. 50141766

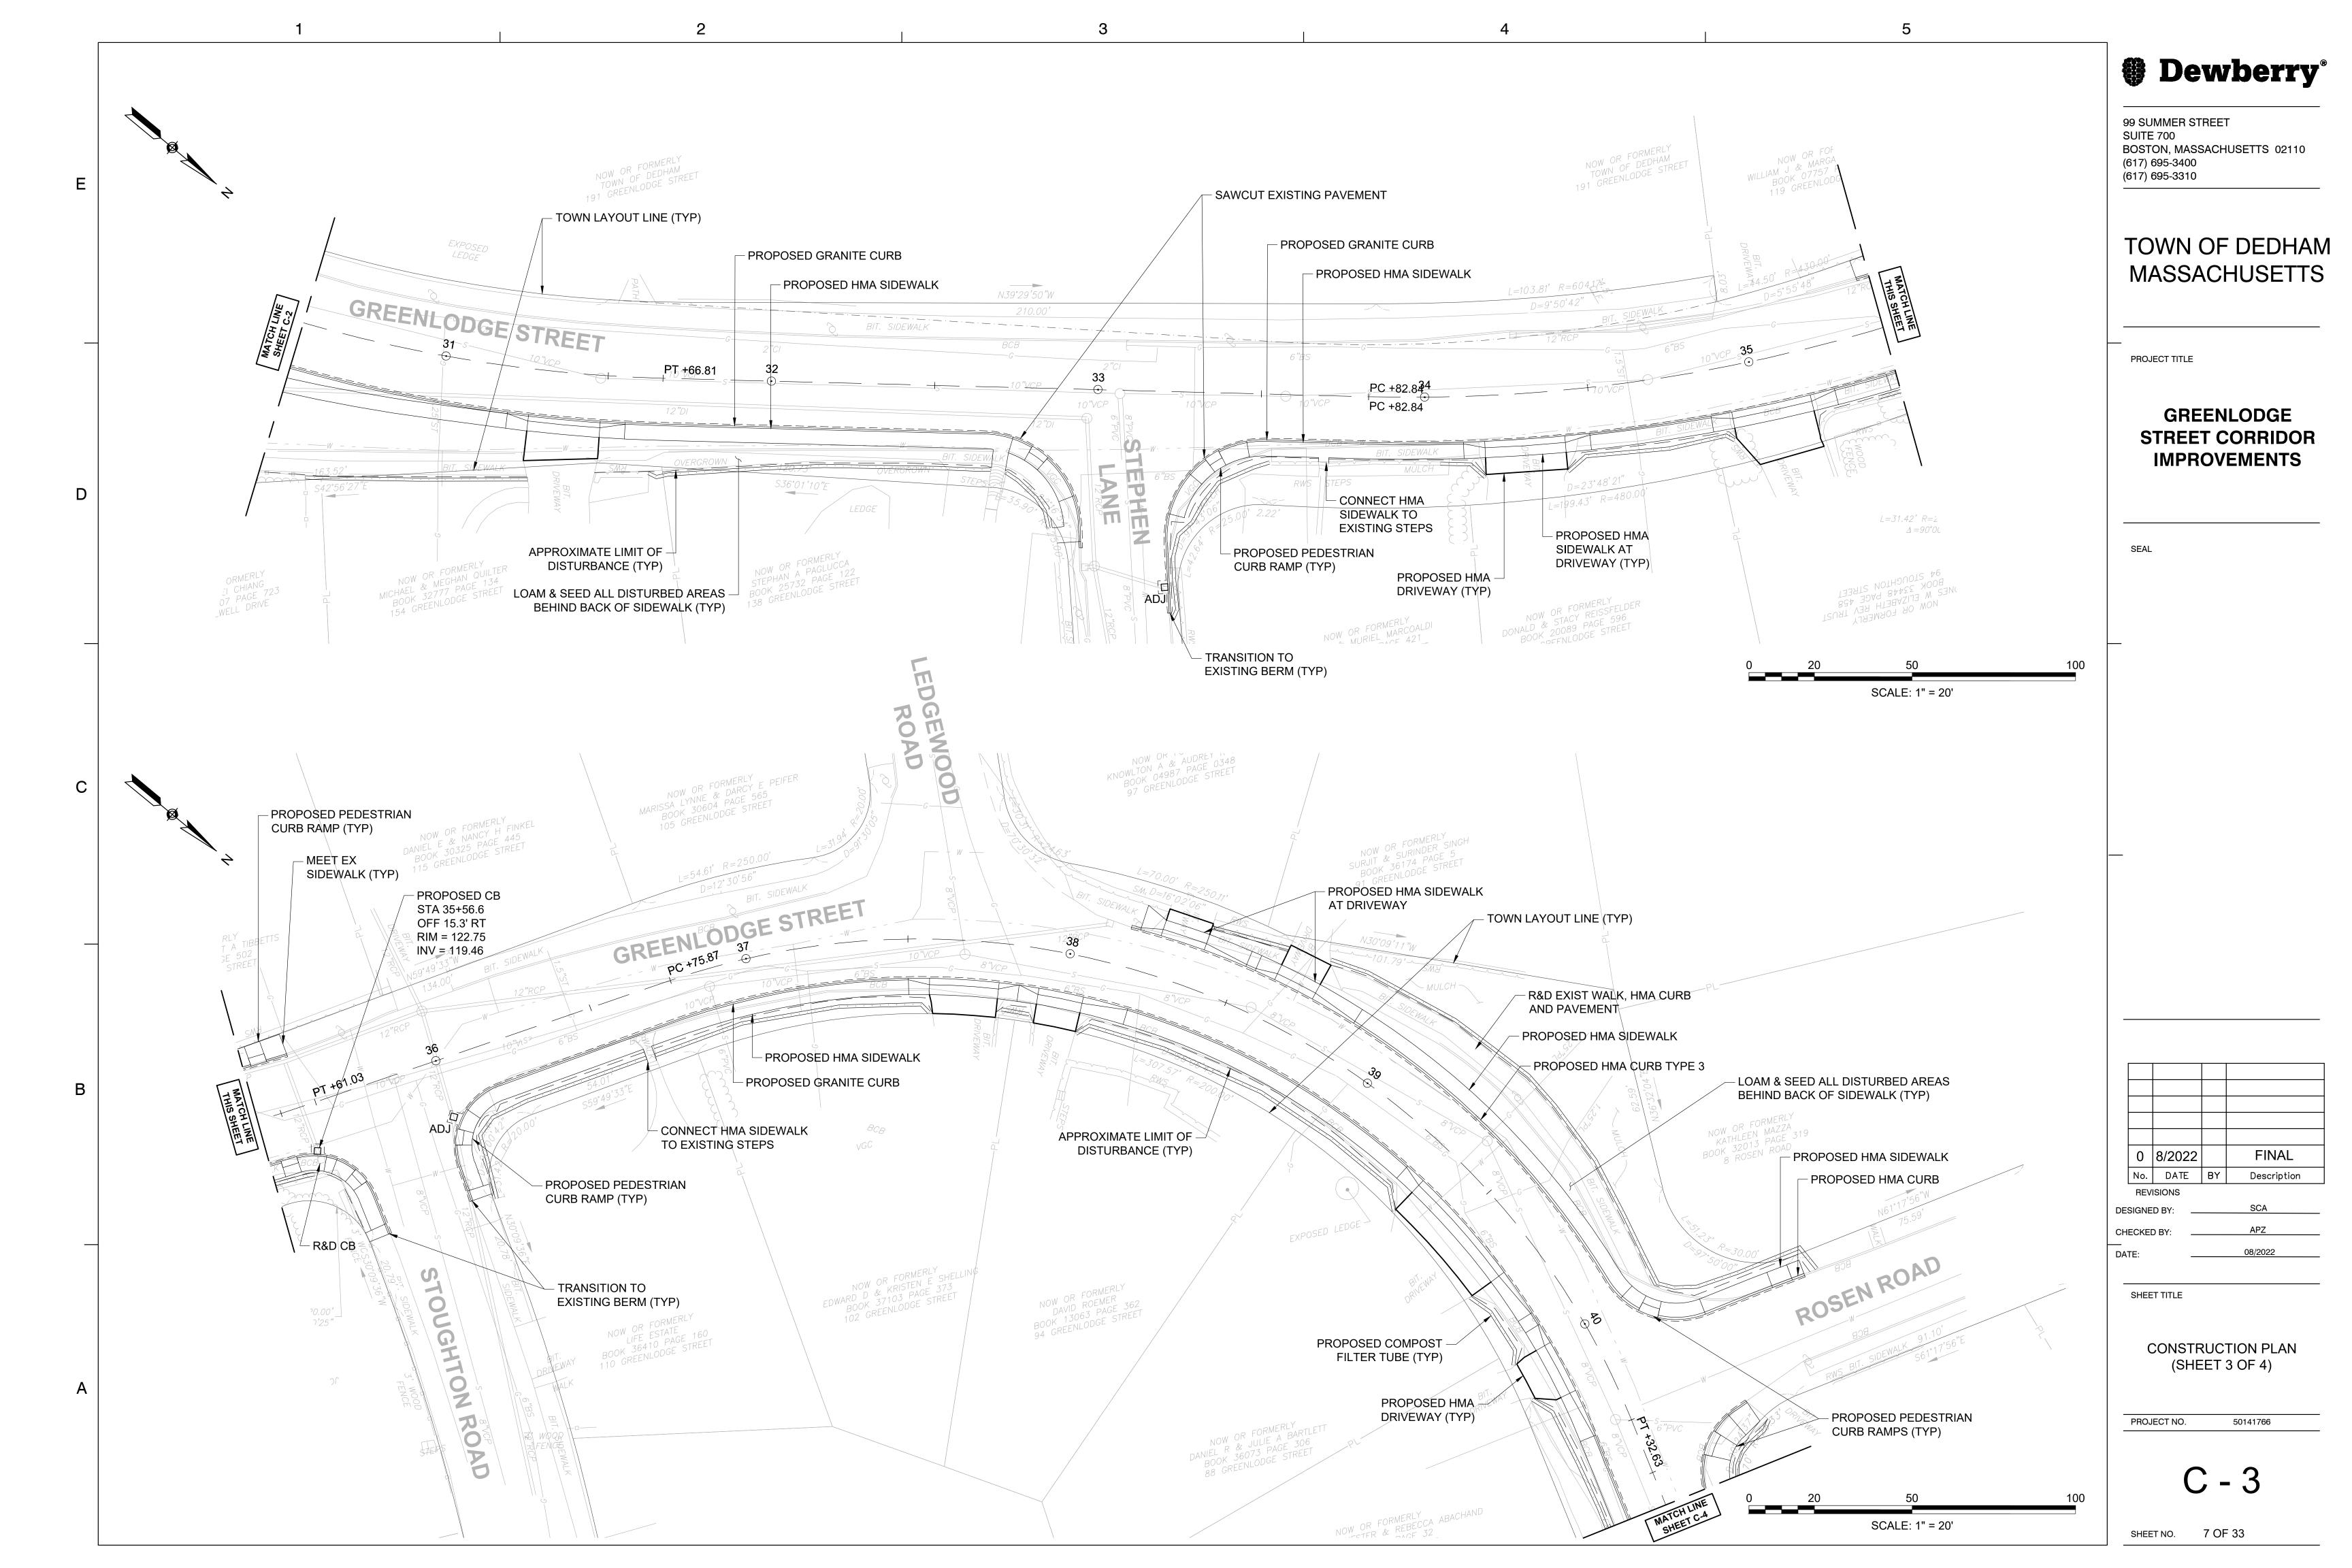
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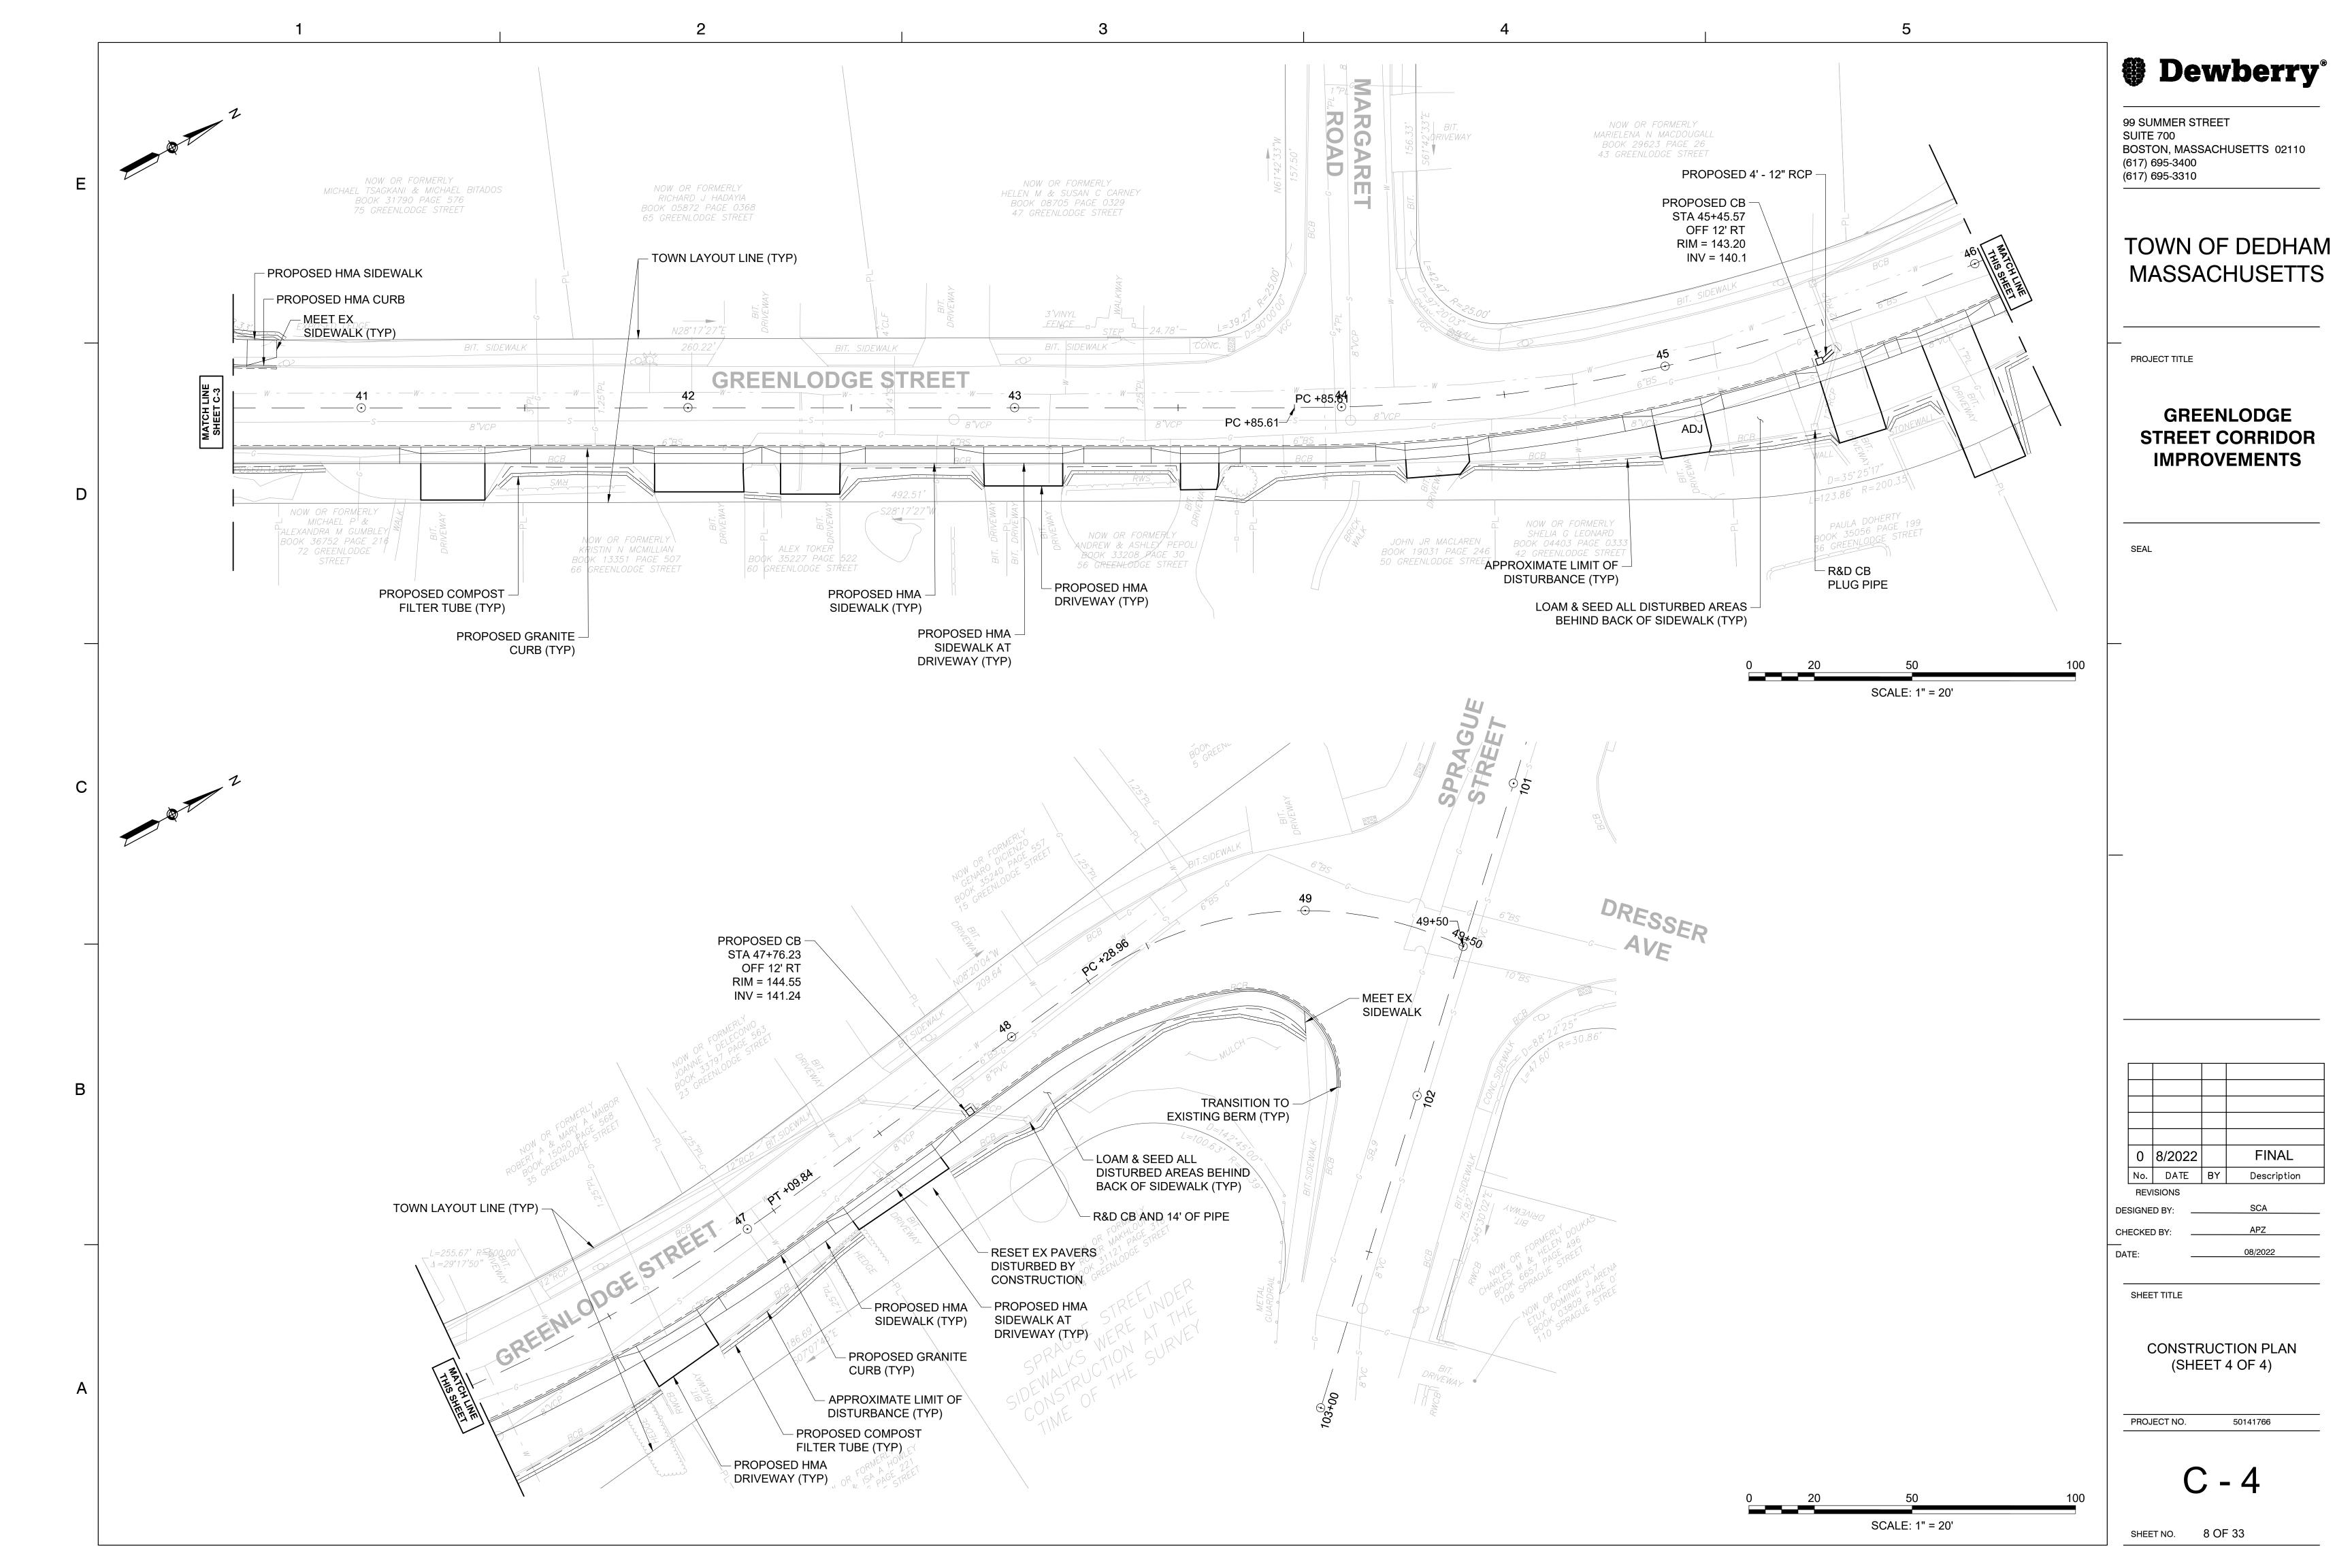
SHEET NO. 4 OF 33


_	11 N.2907985, 8481 E.749053, 2894 2.128, 91 MNS 39 OIRF 7-5PKF LDT CDR MNSPIKE
С	PC +75.87 O IRF O IRF
В	13 N 200857 7.312 E749275.8085 S27-11 22.75 W 14 15.08 15 N 200817 7.3105 E749275.8085 E749275
A	19.50













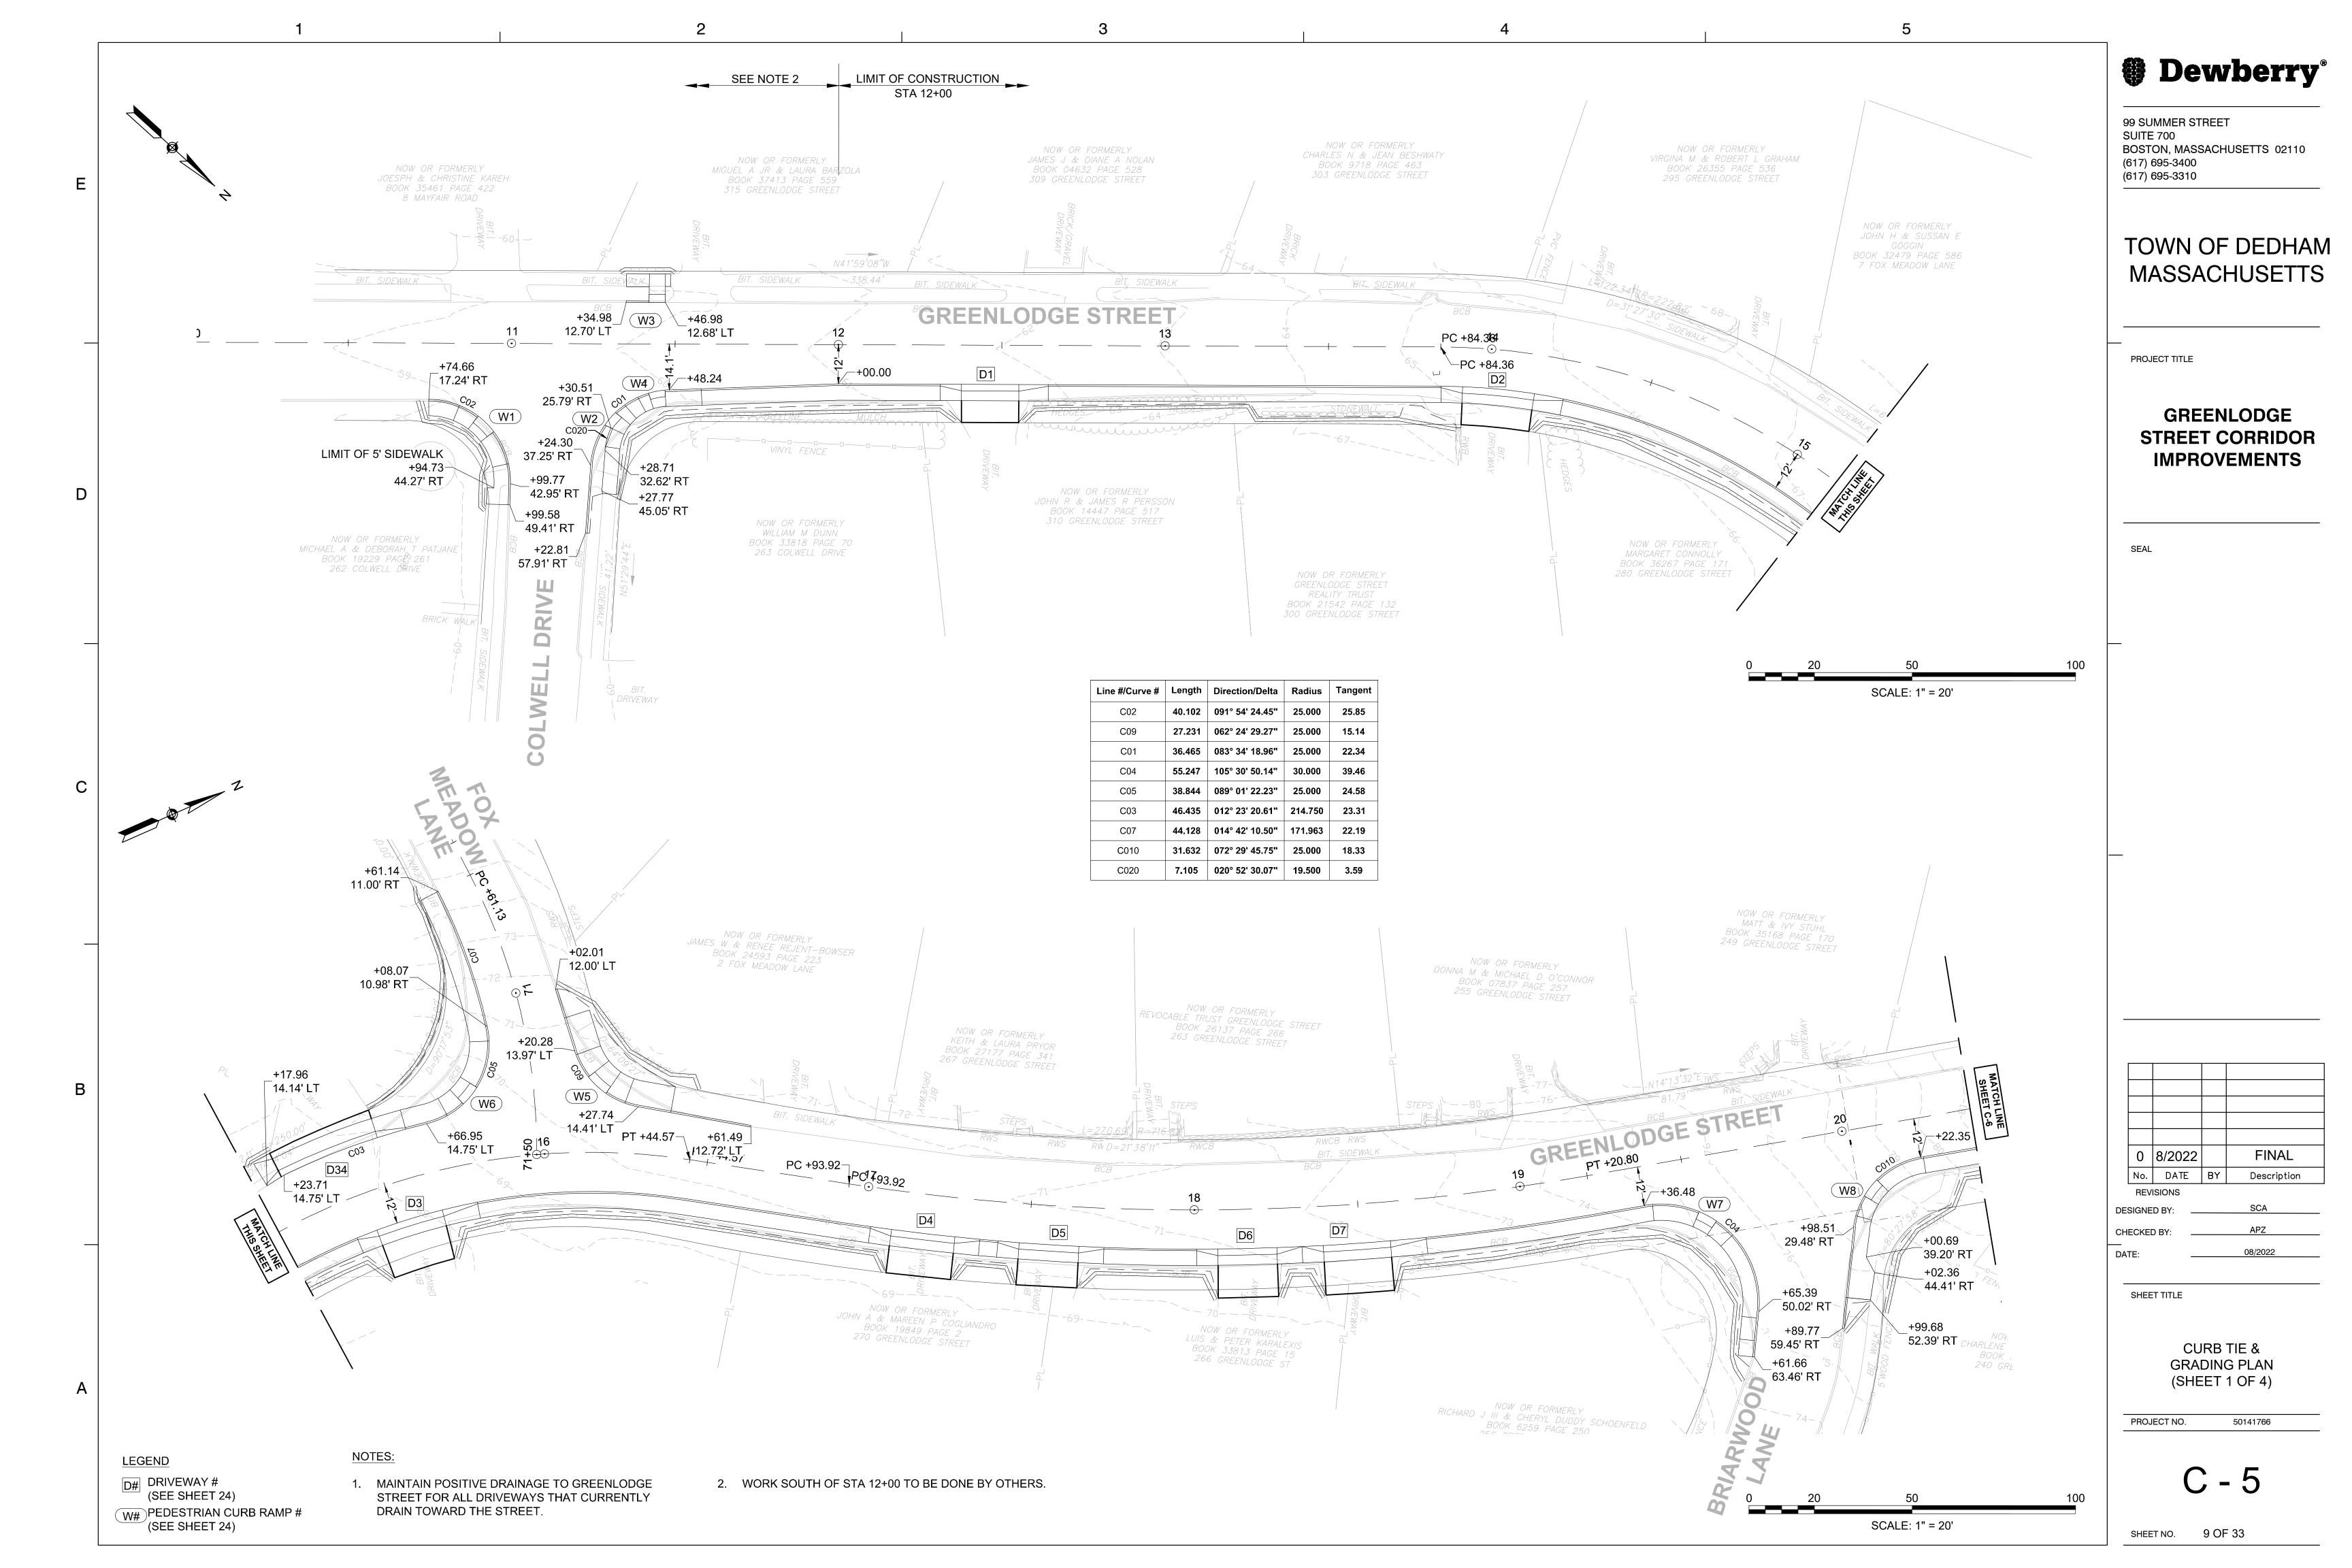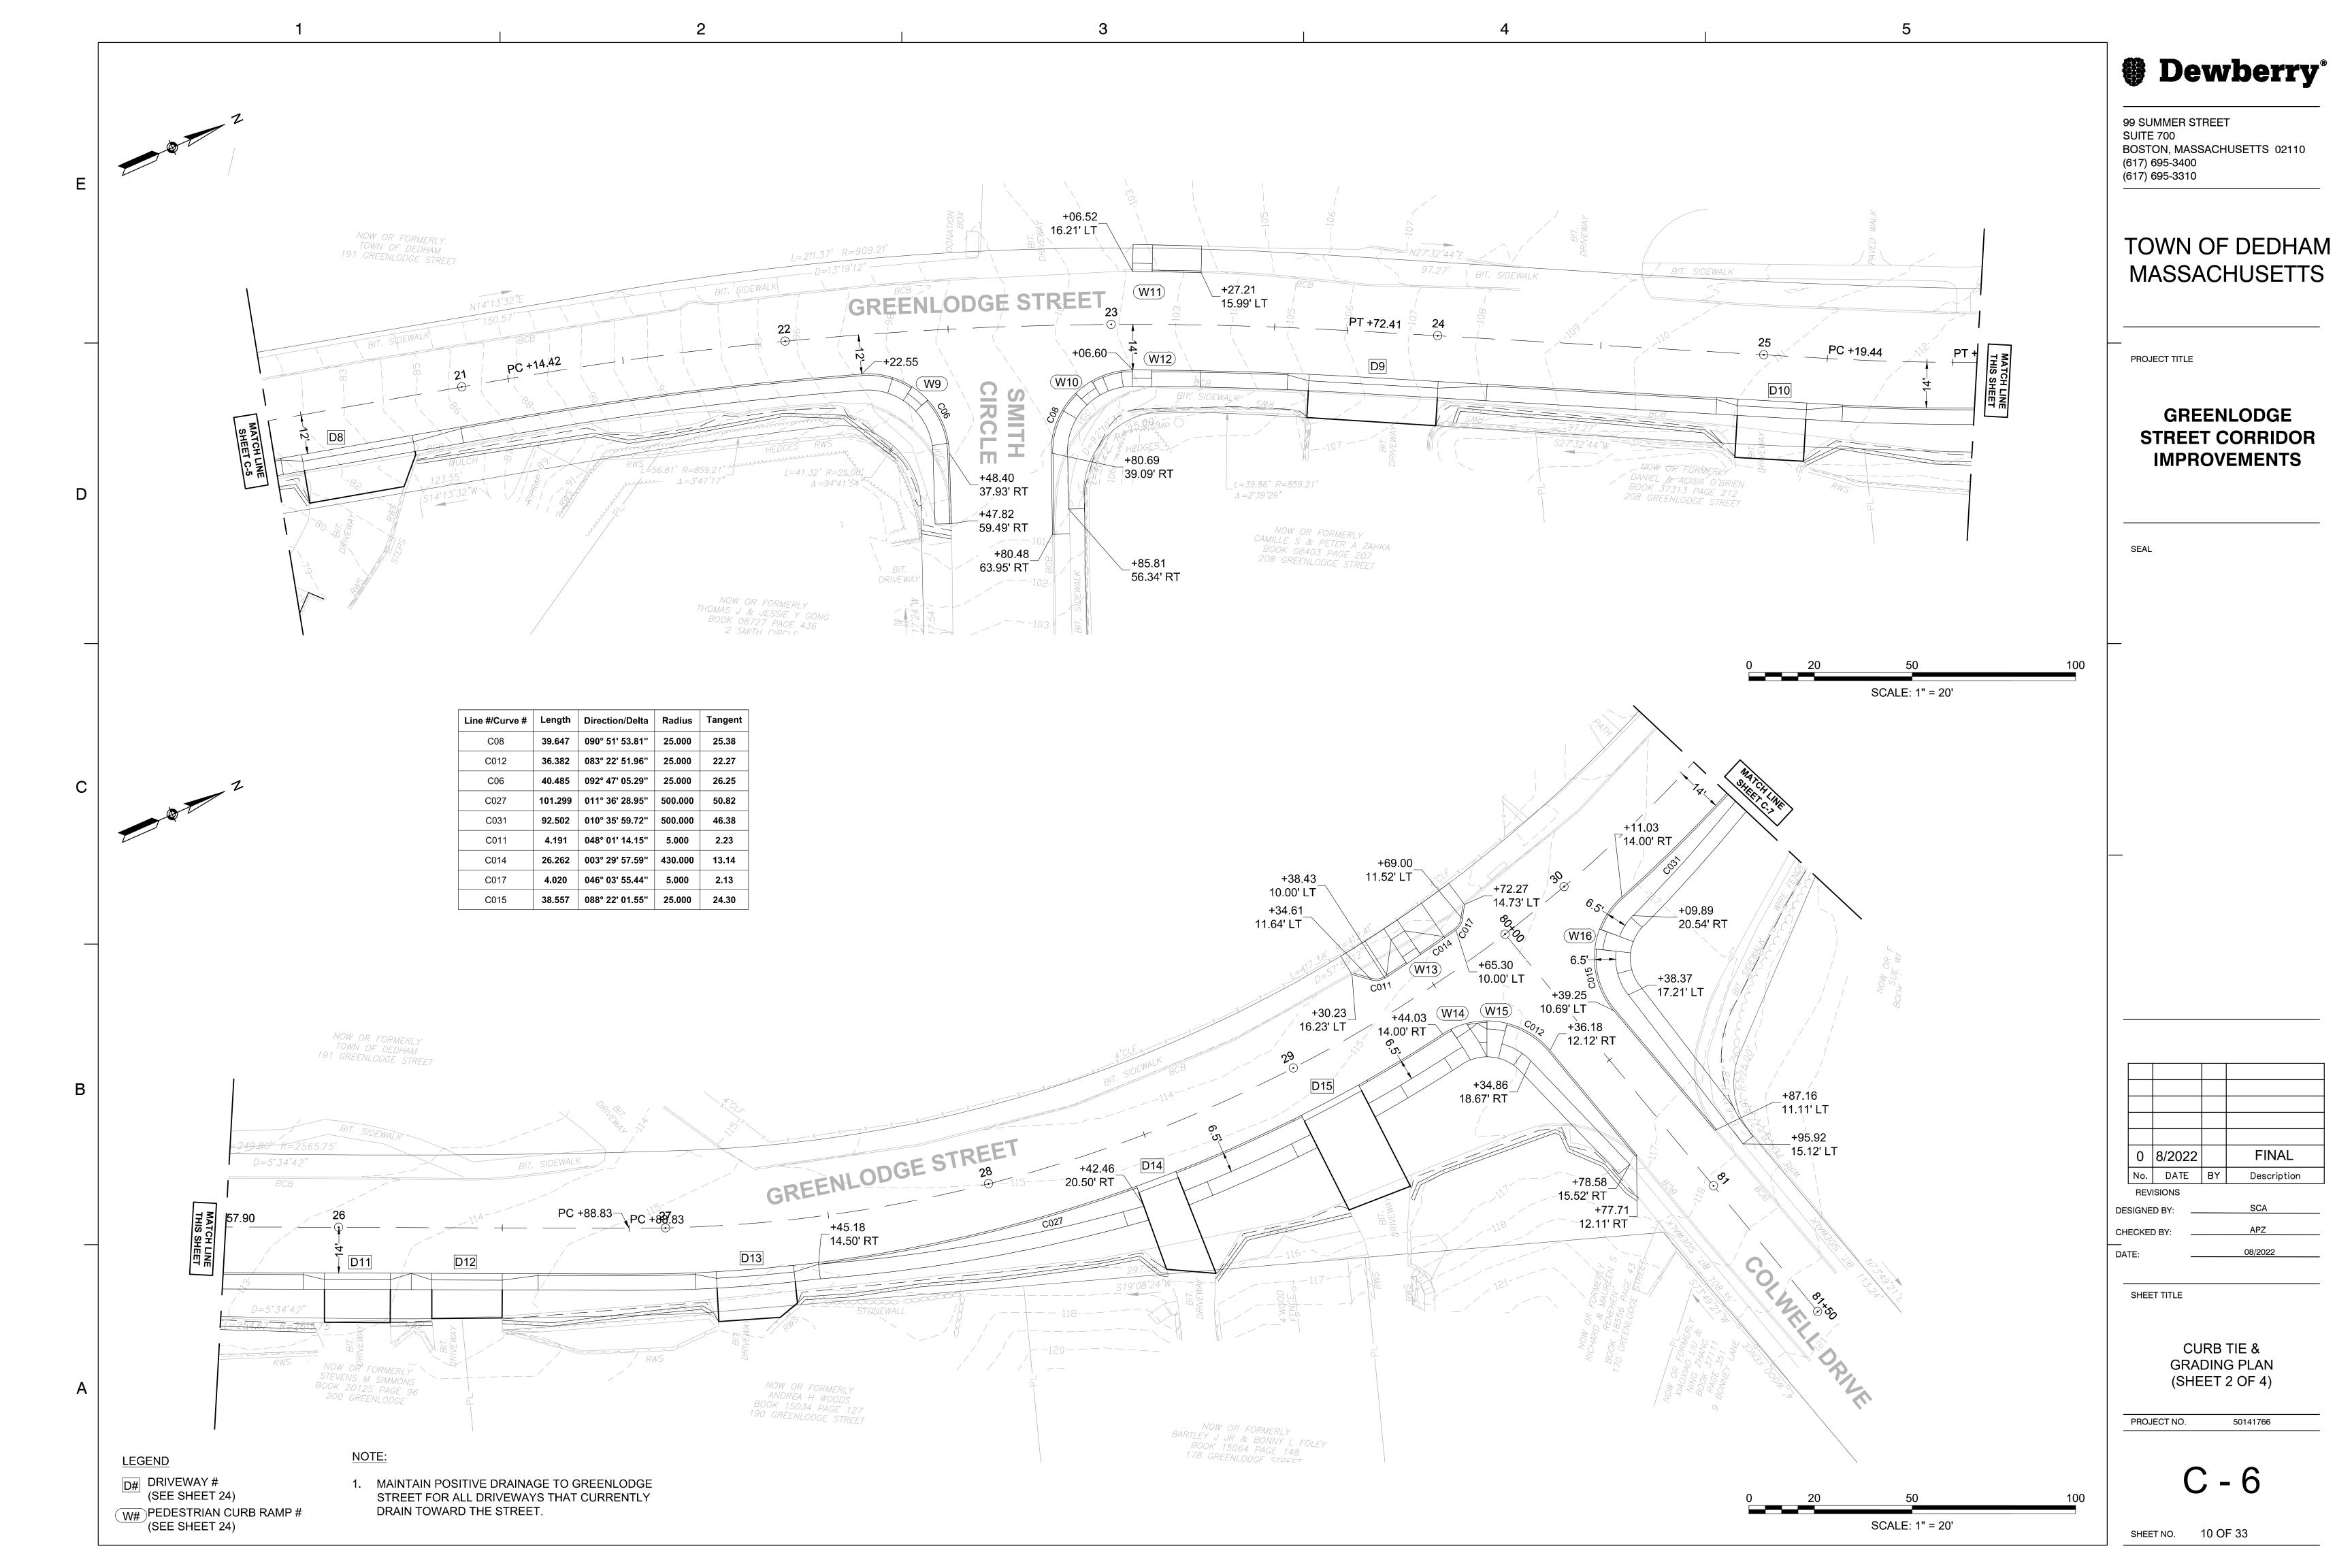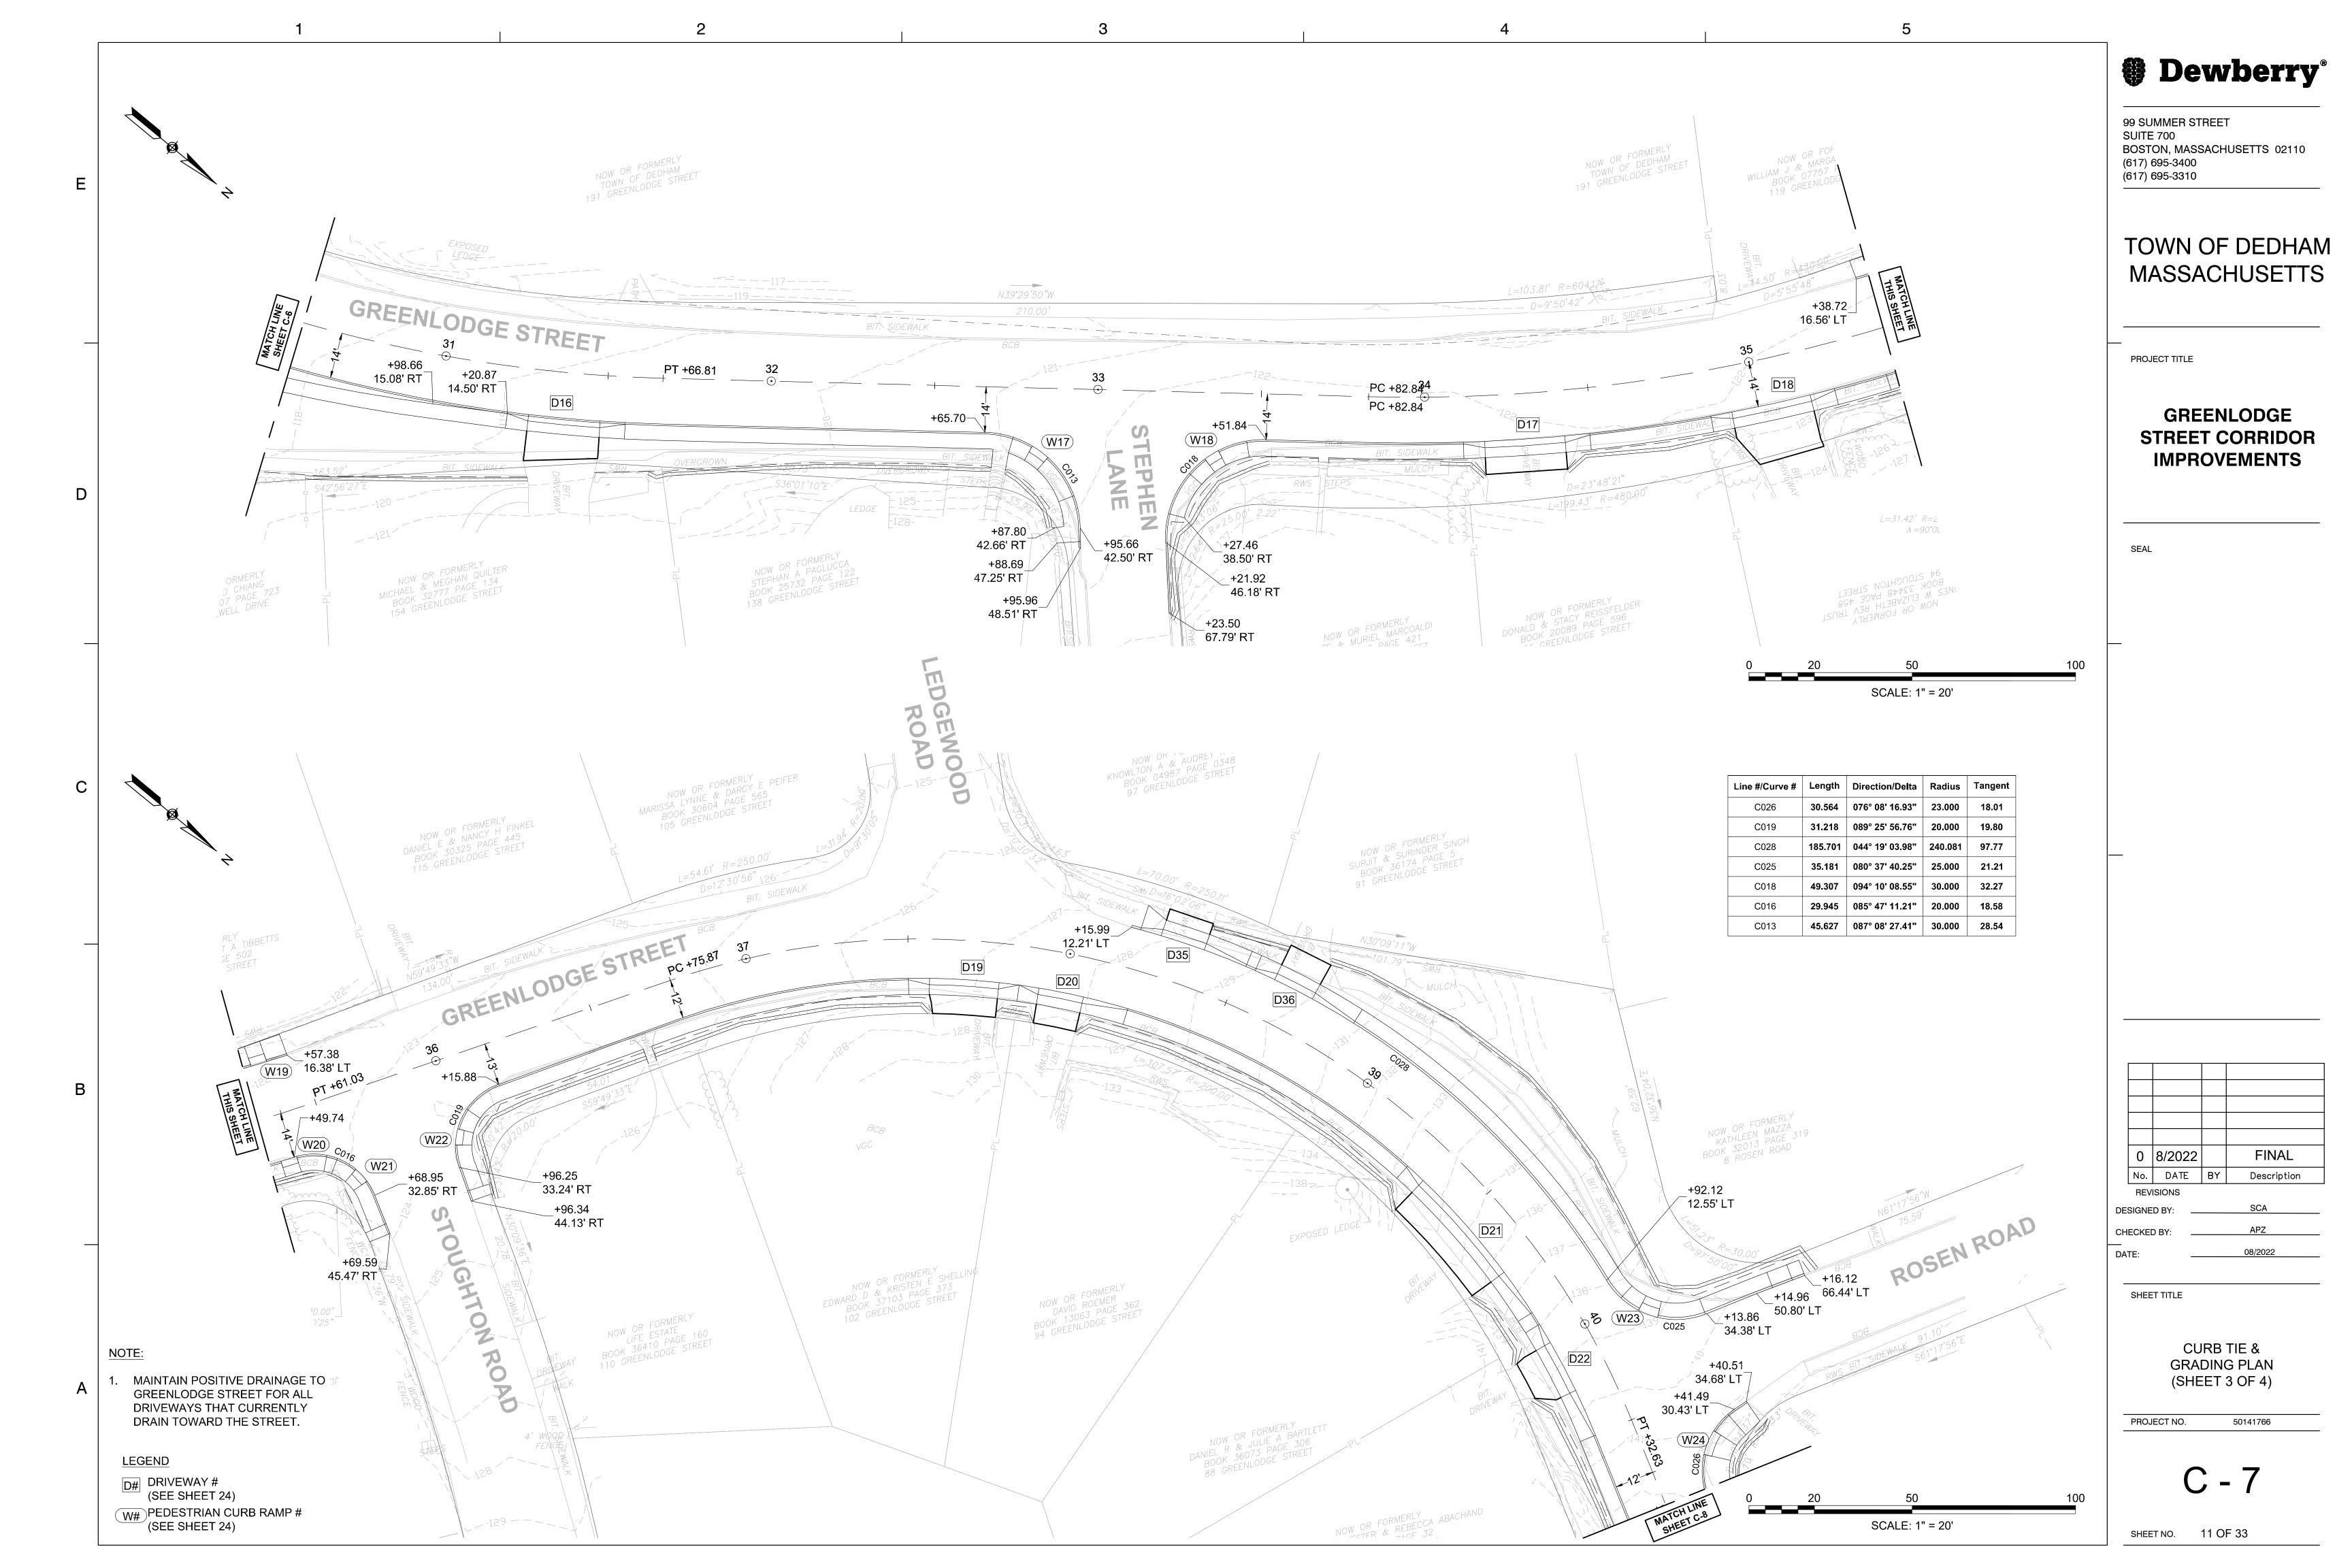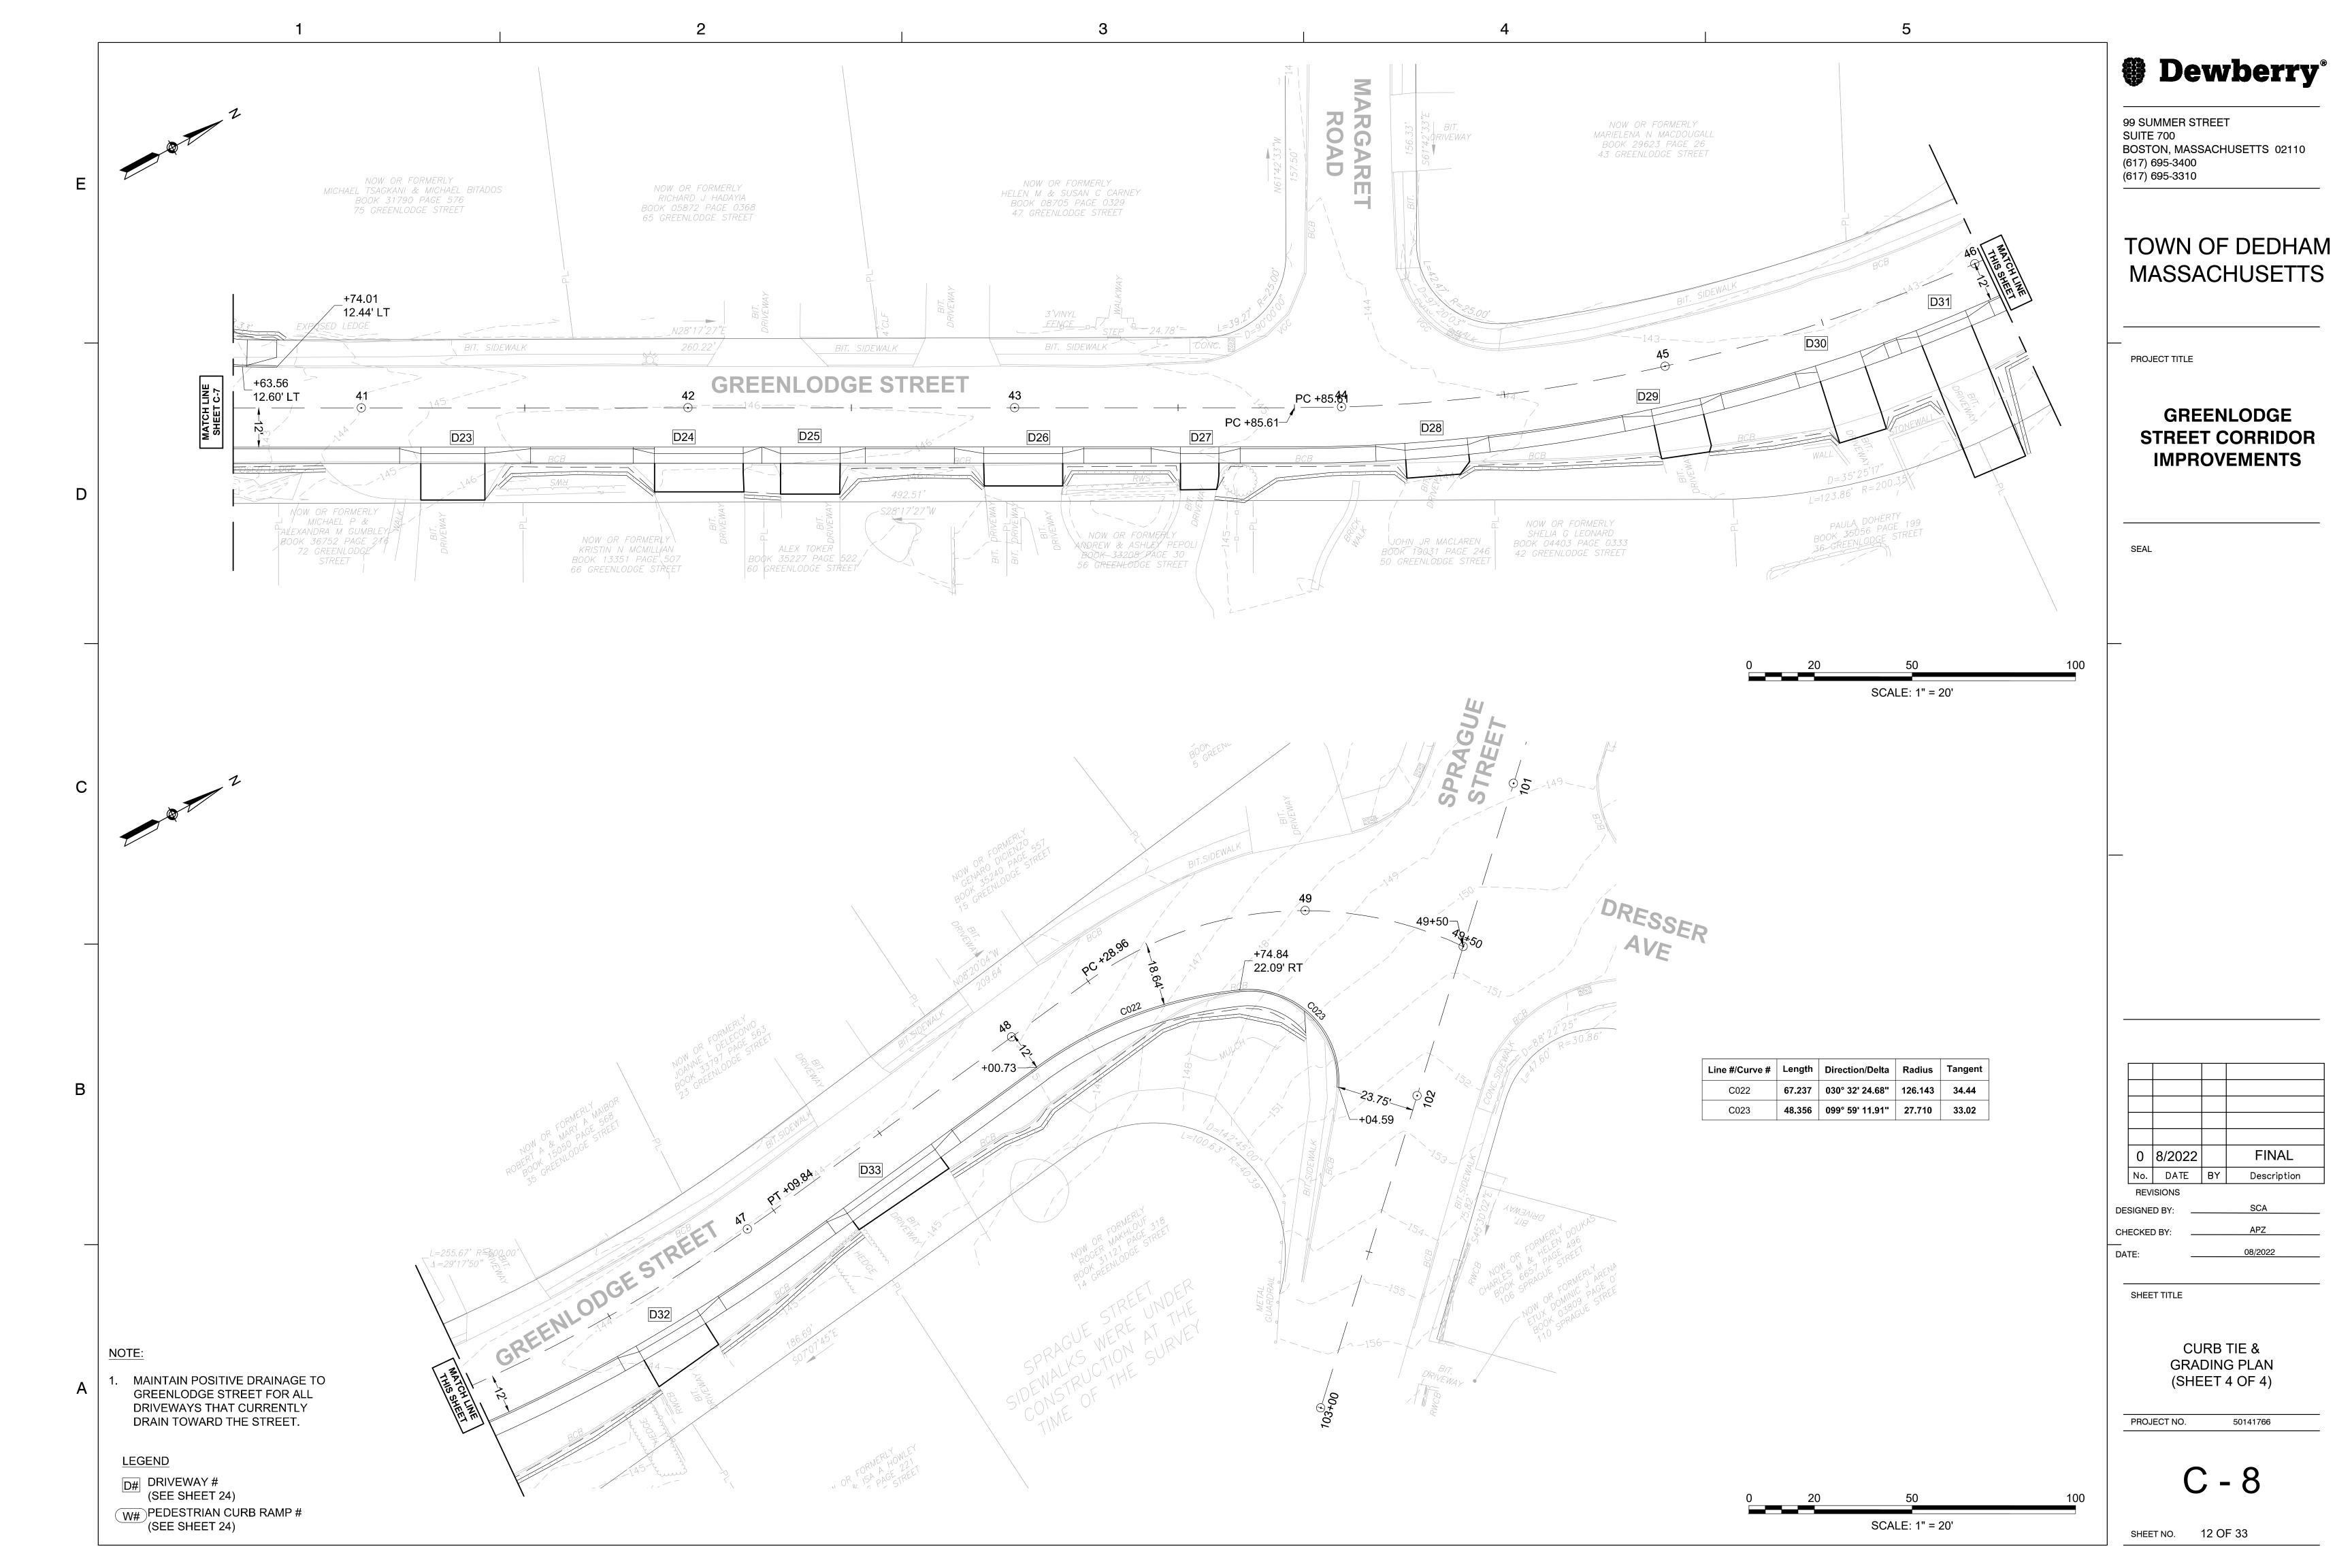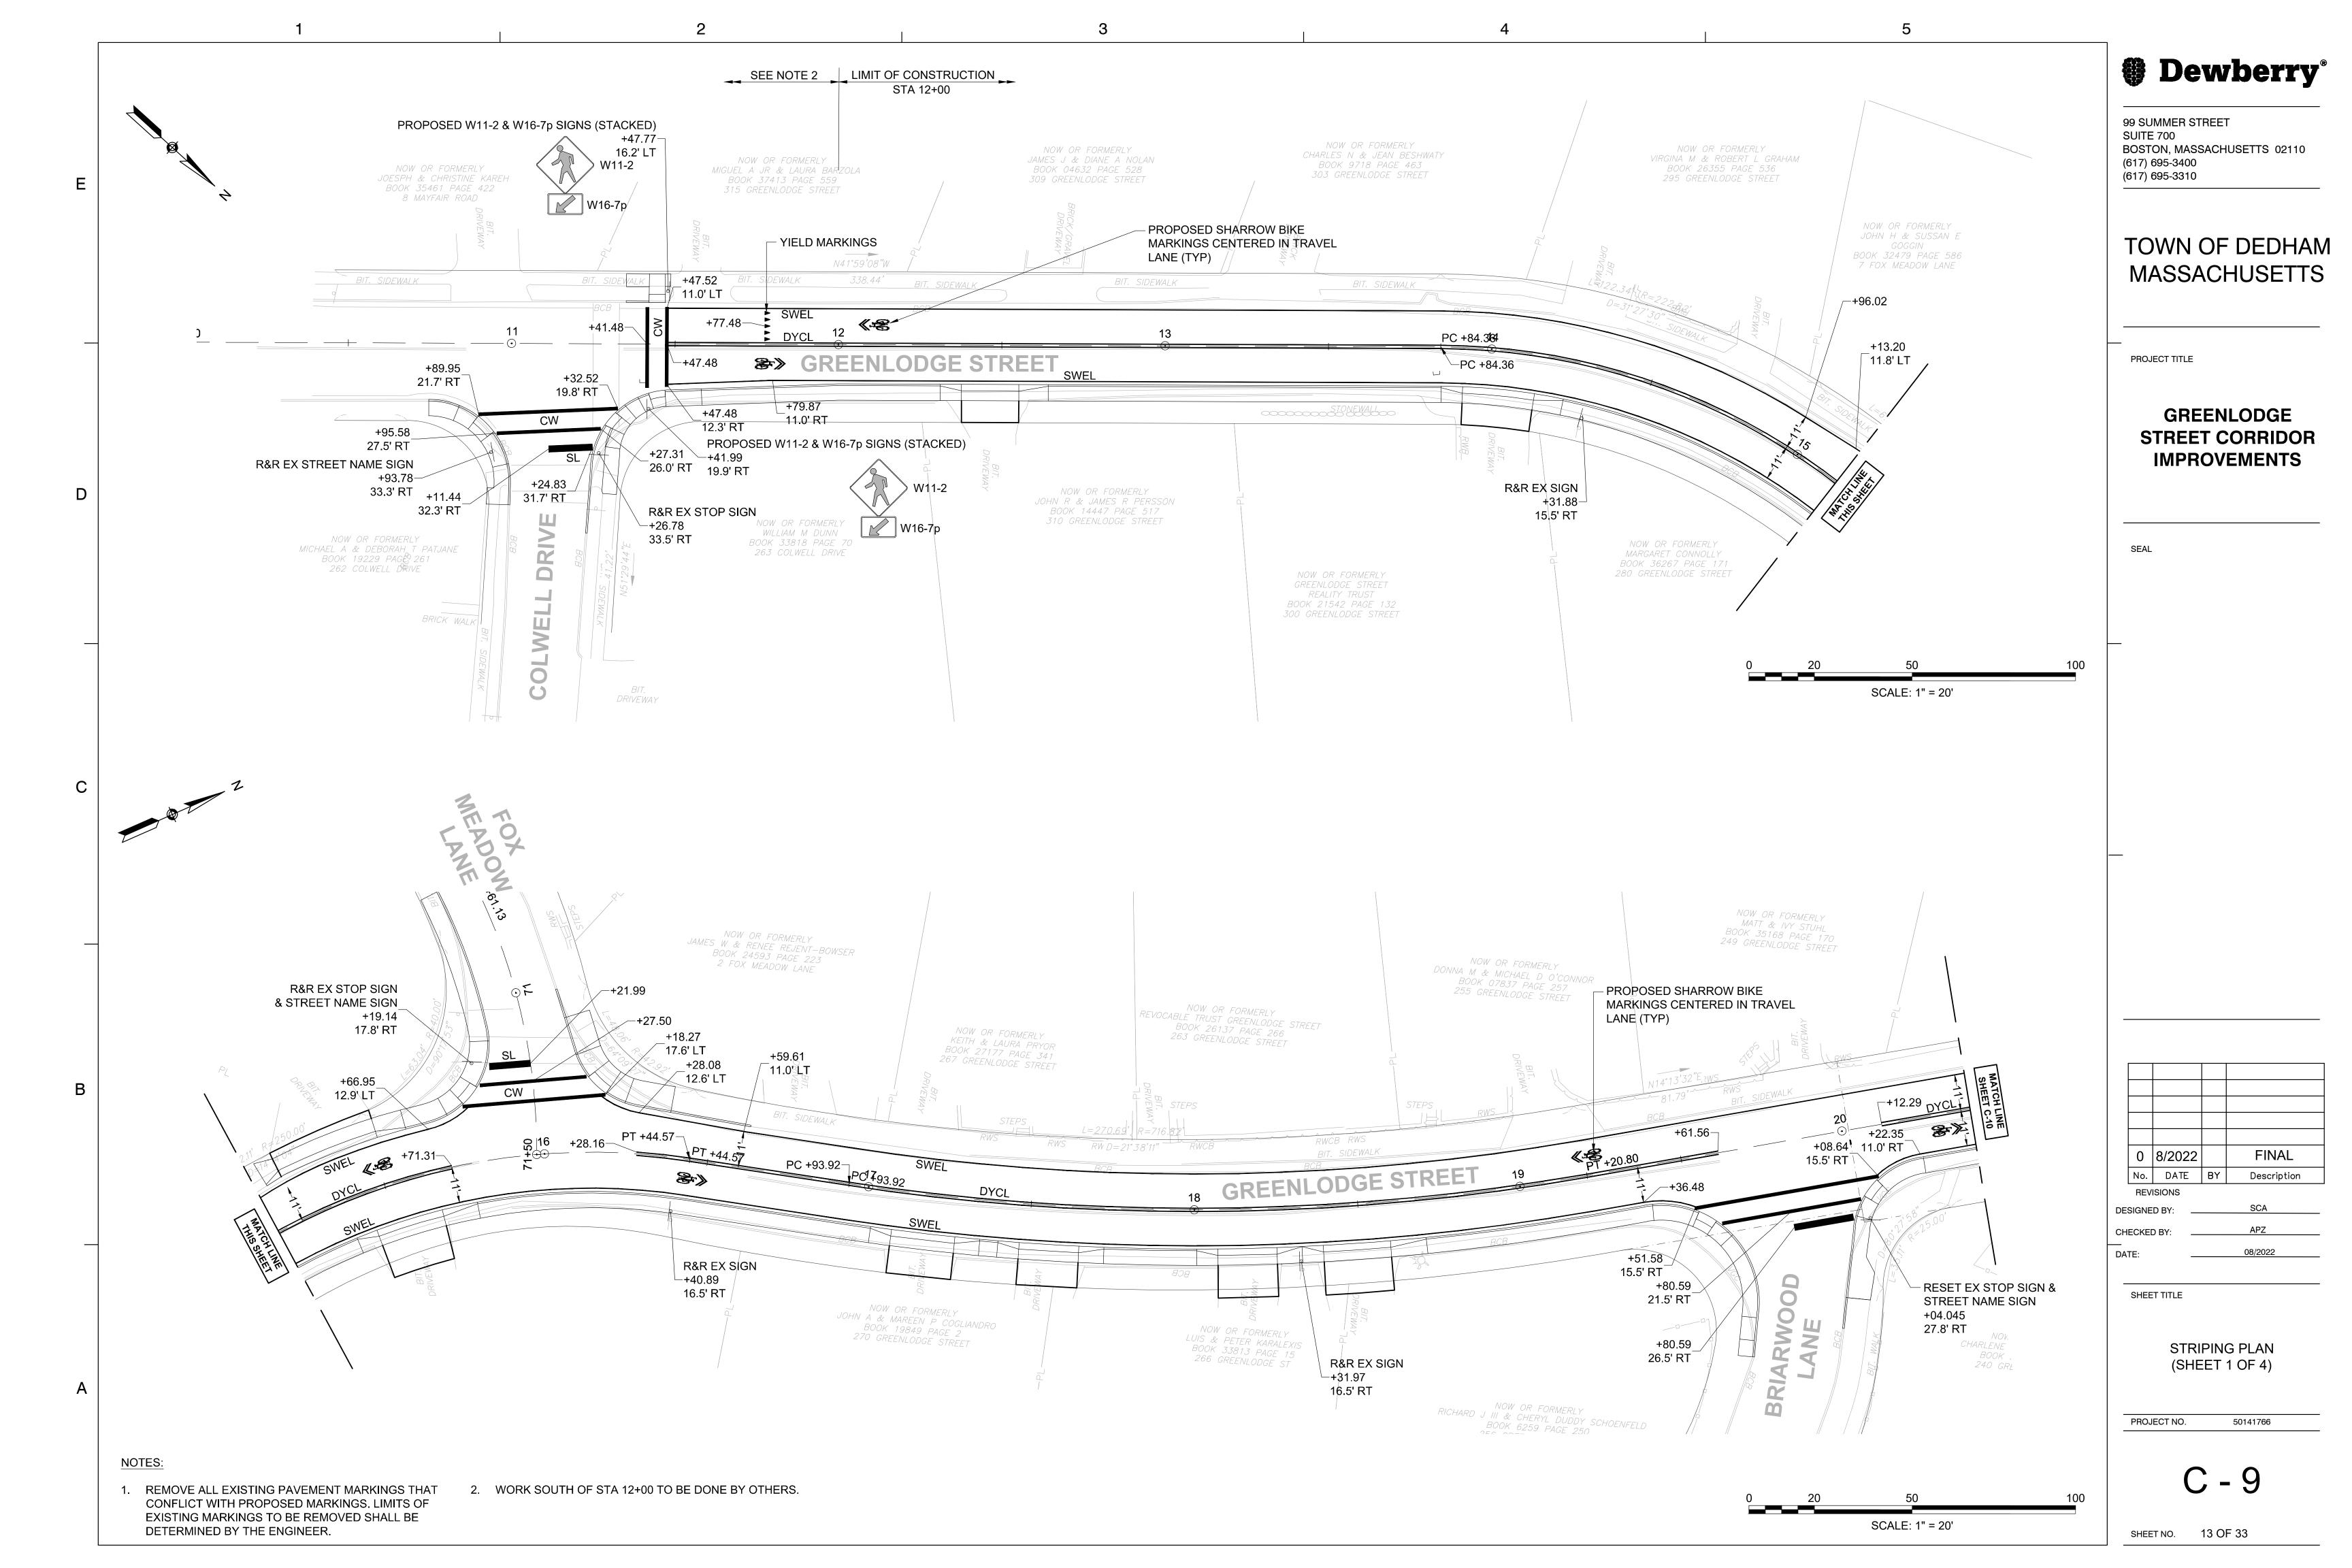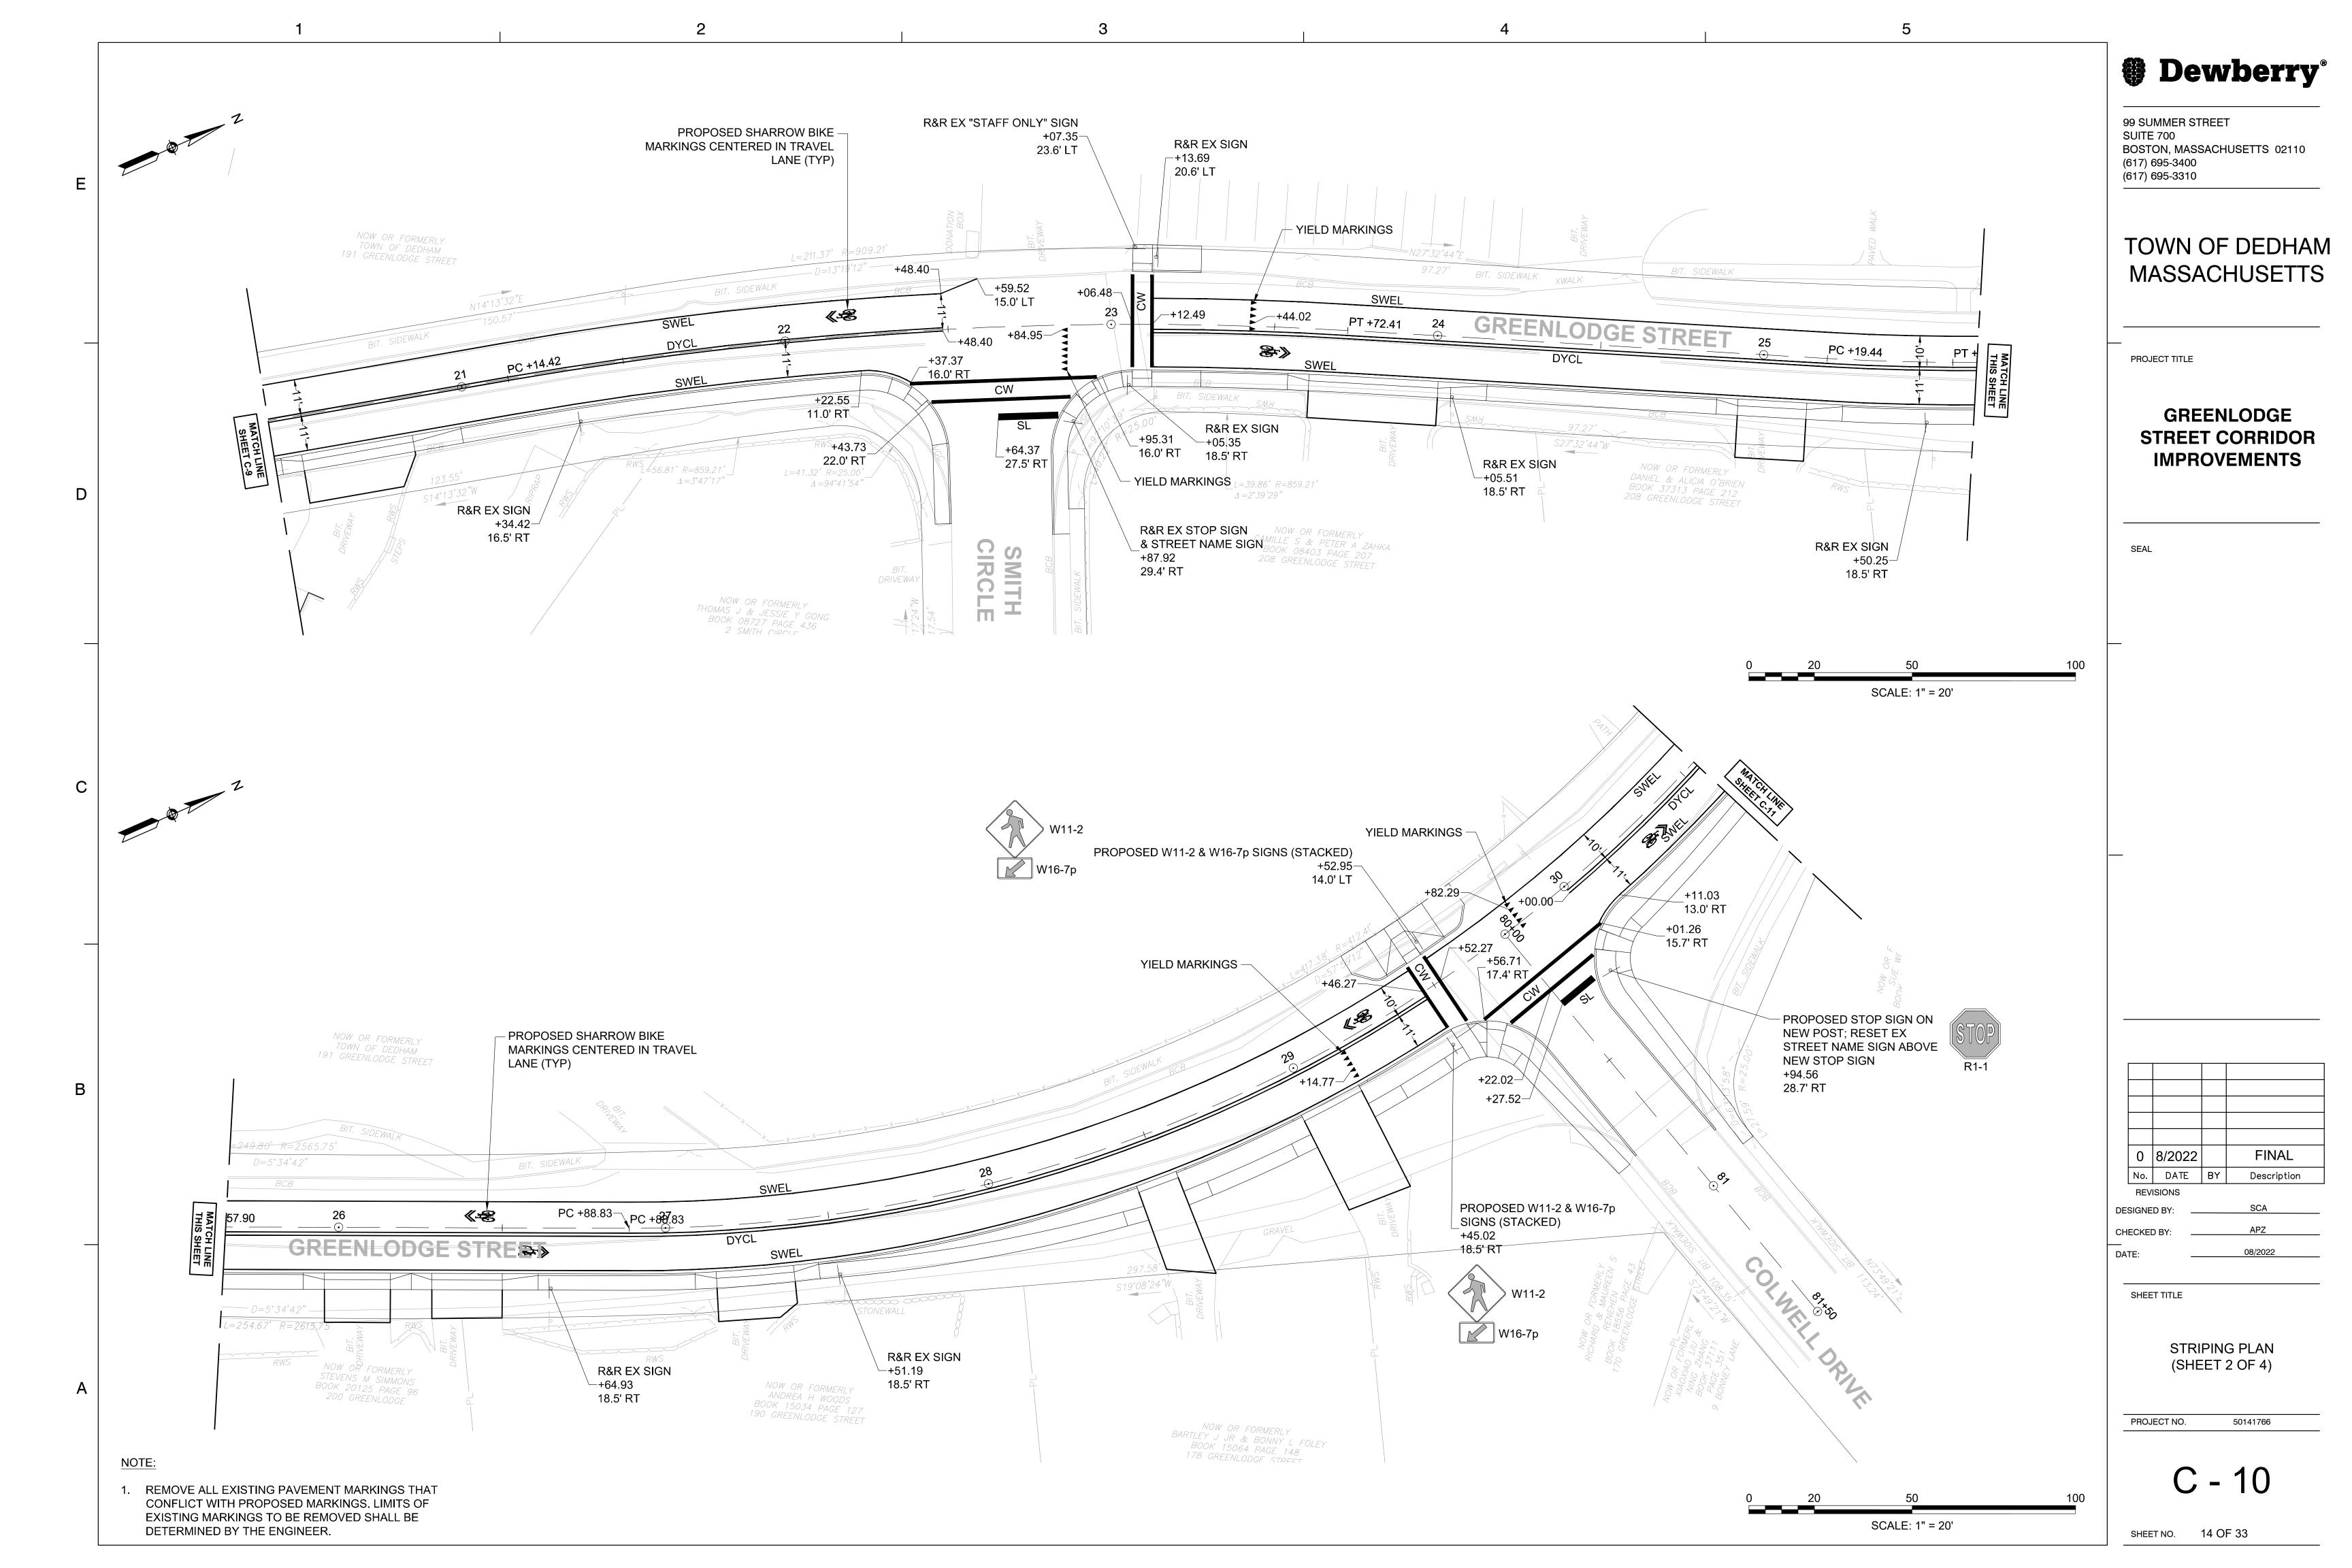


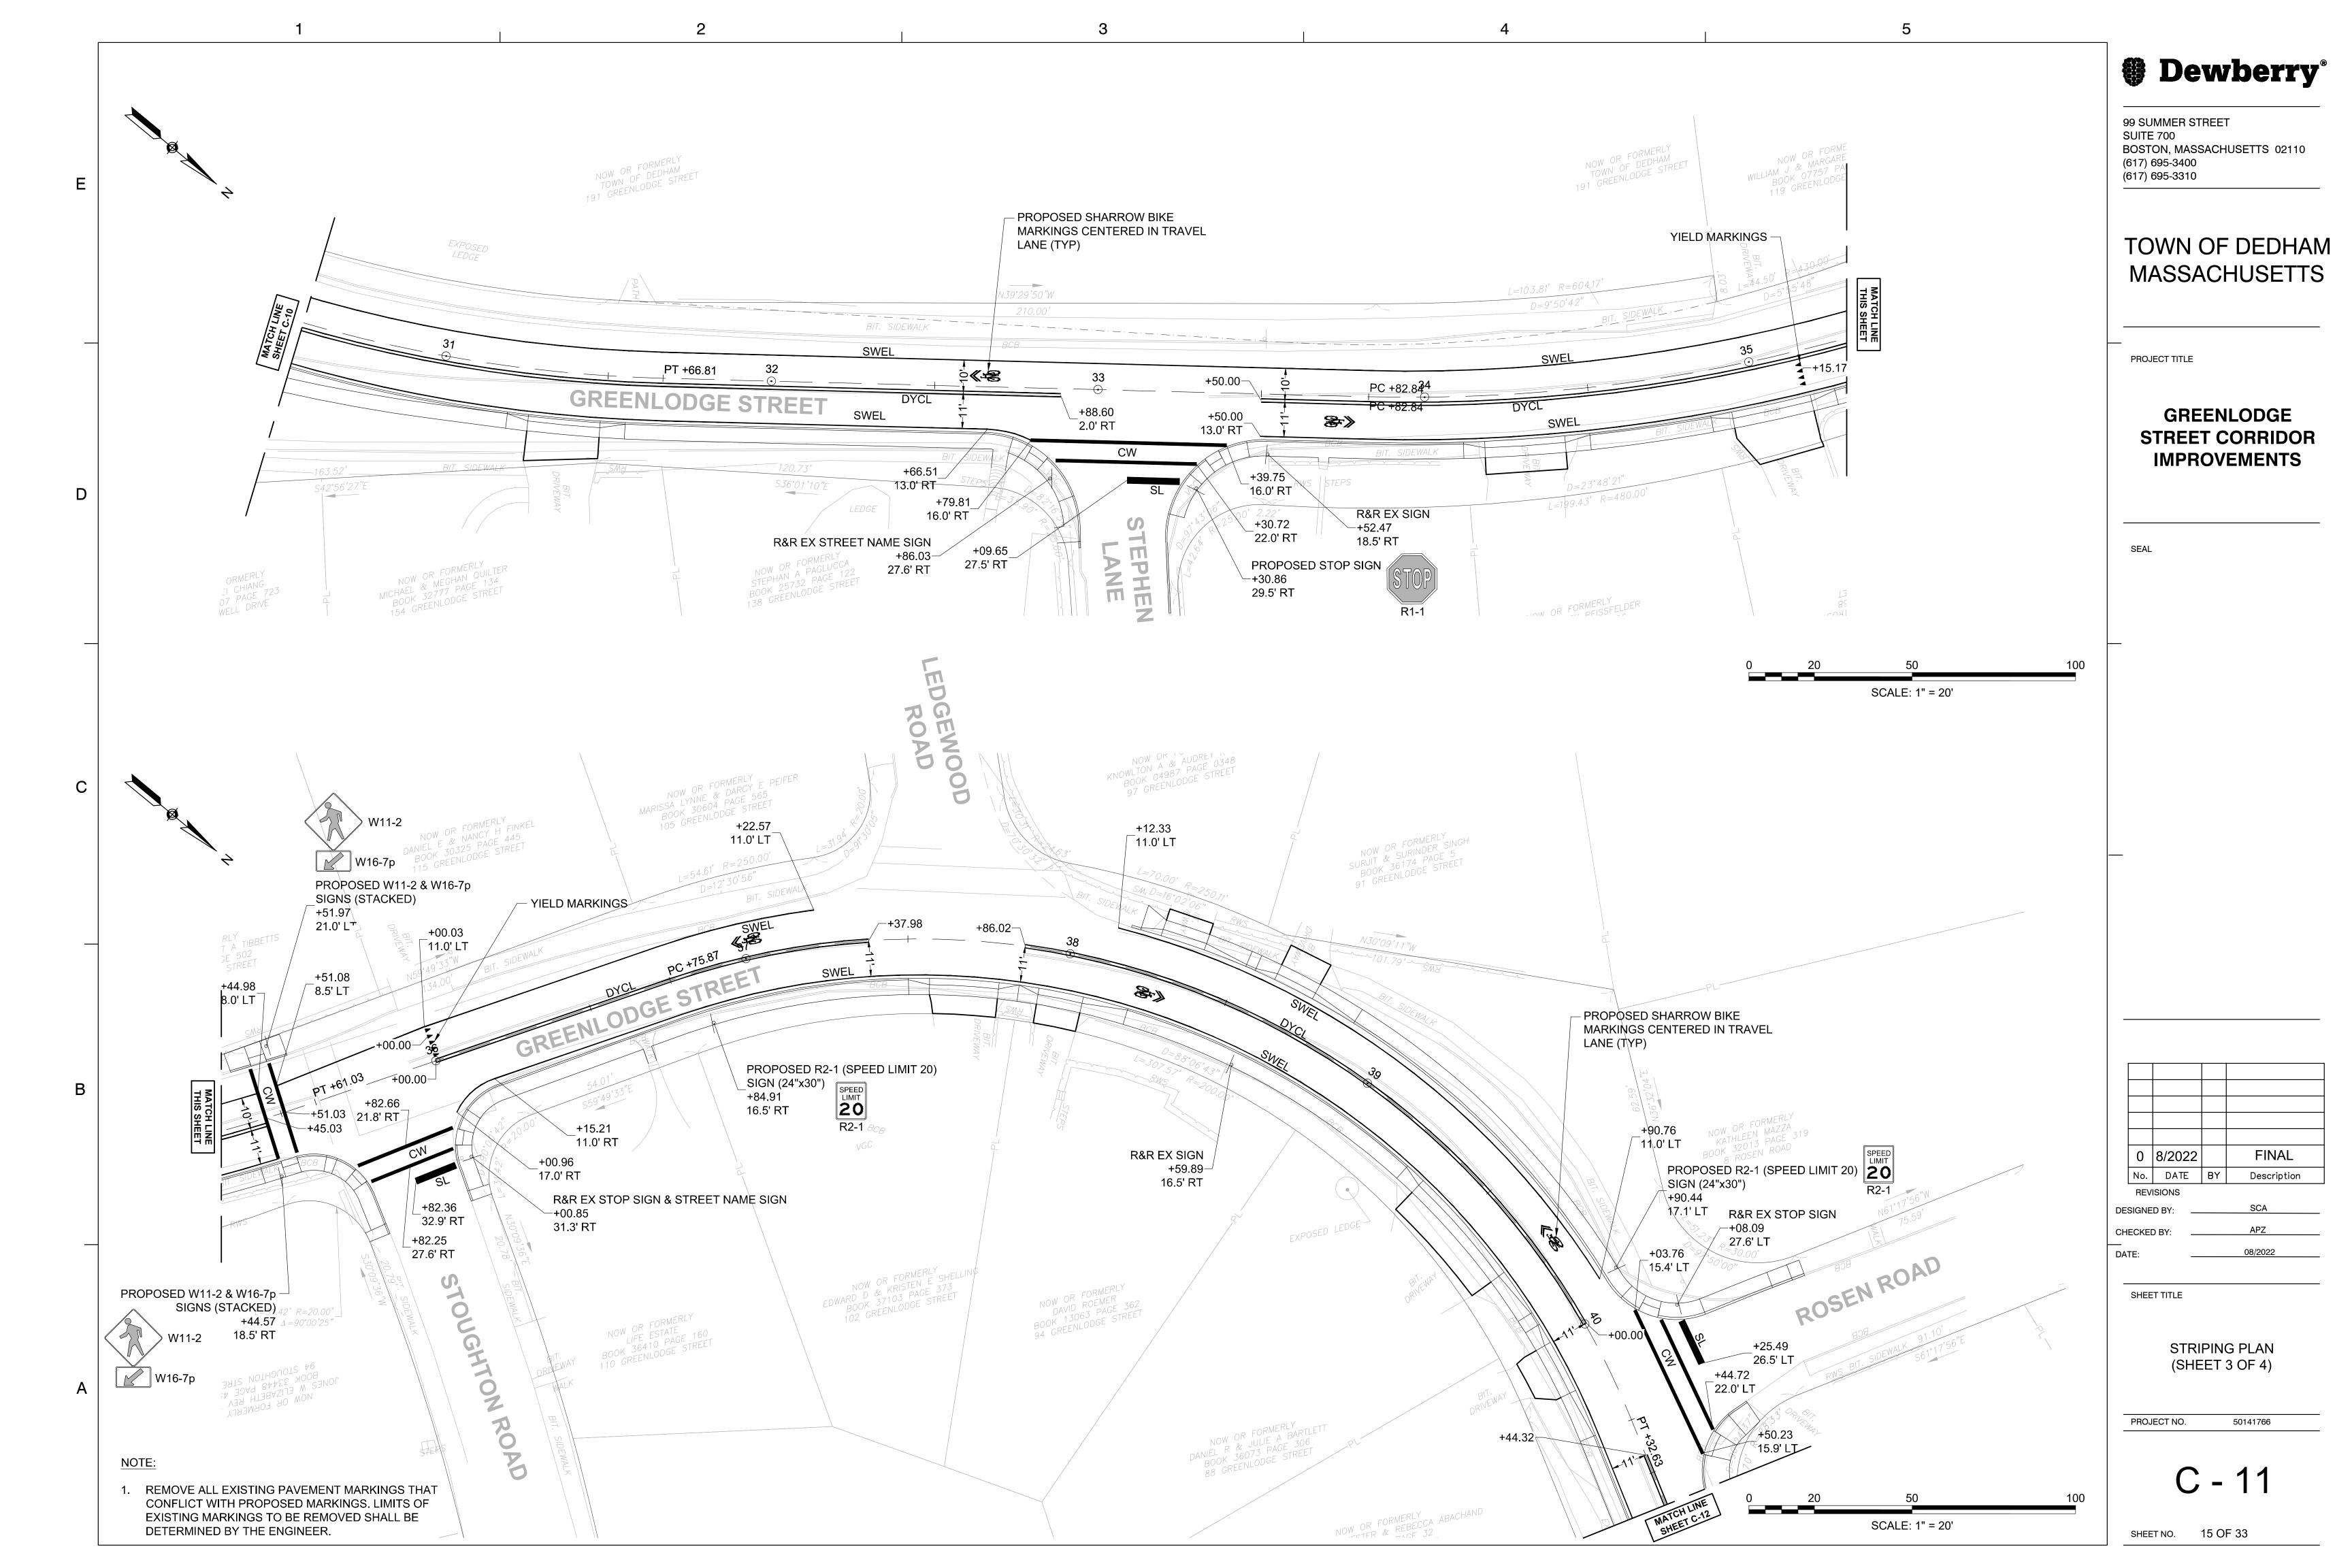


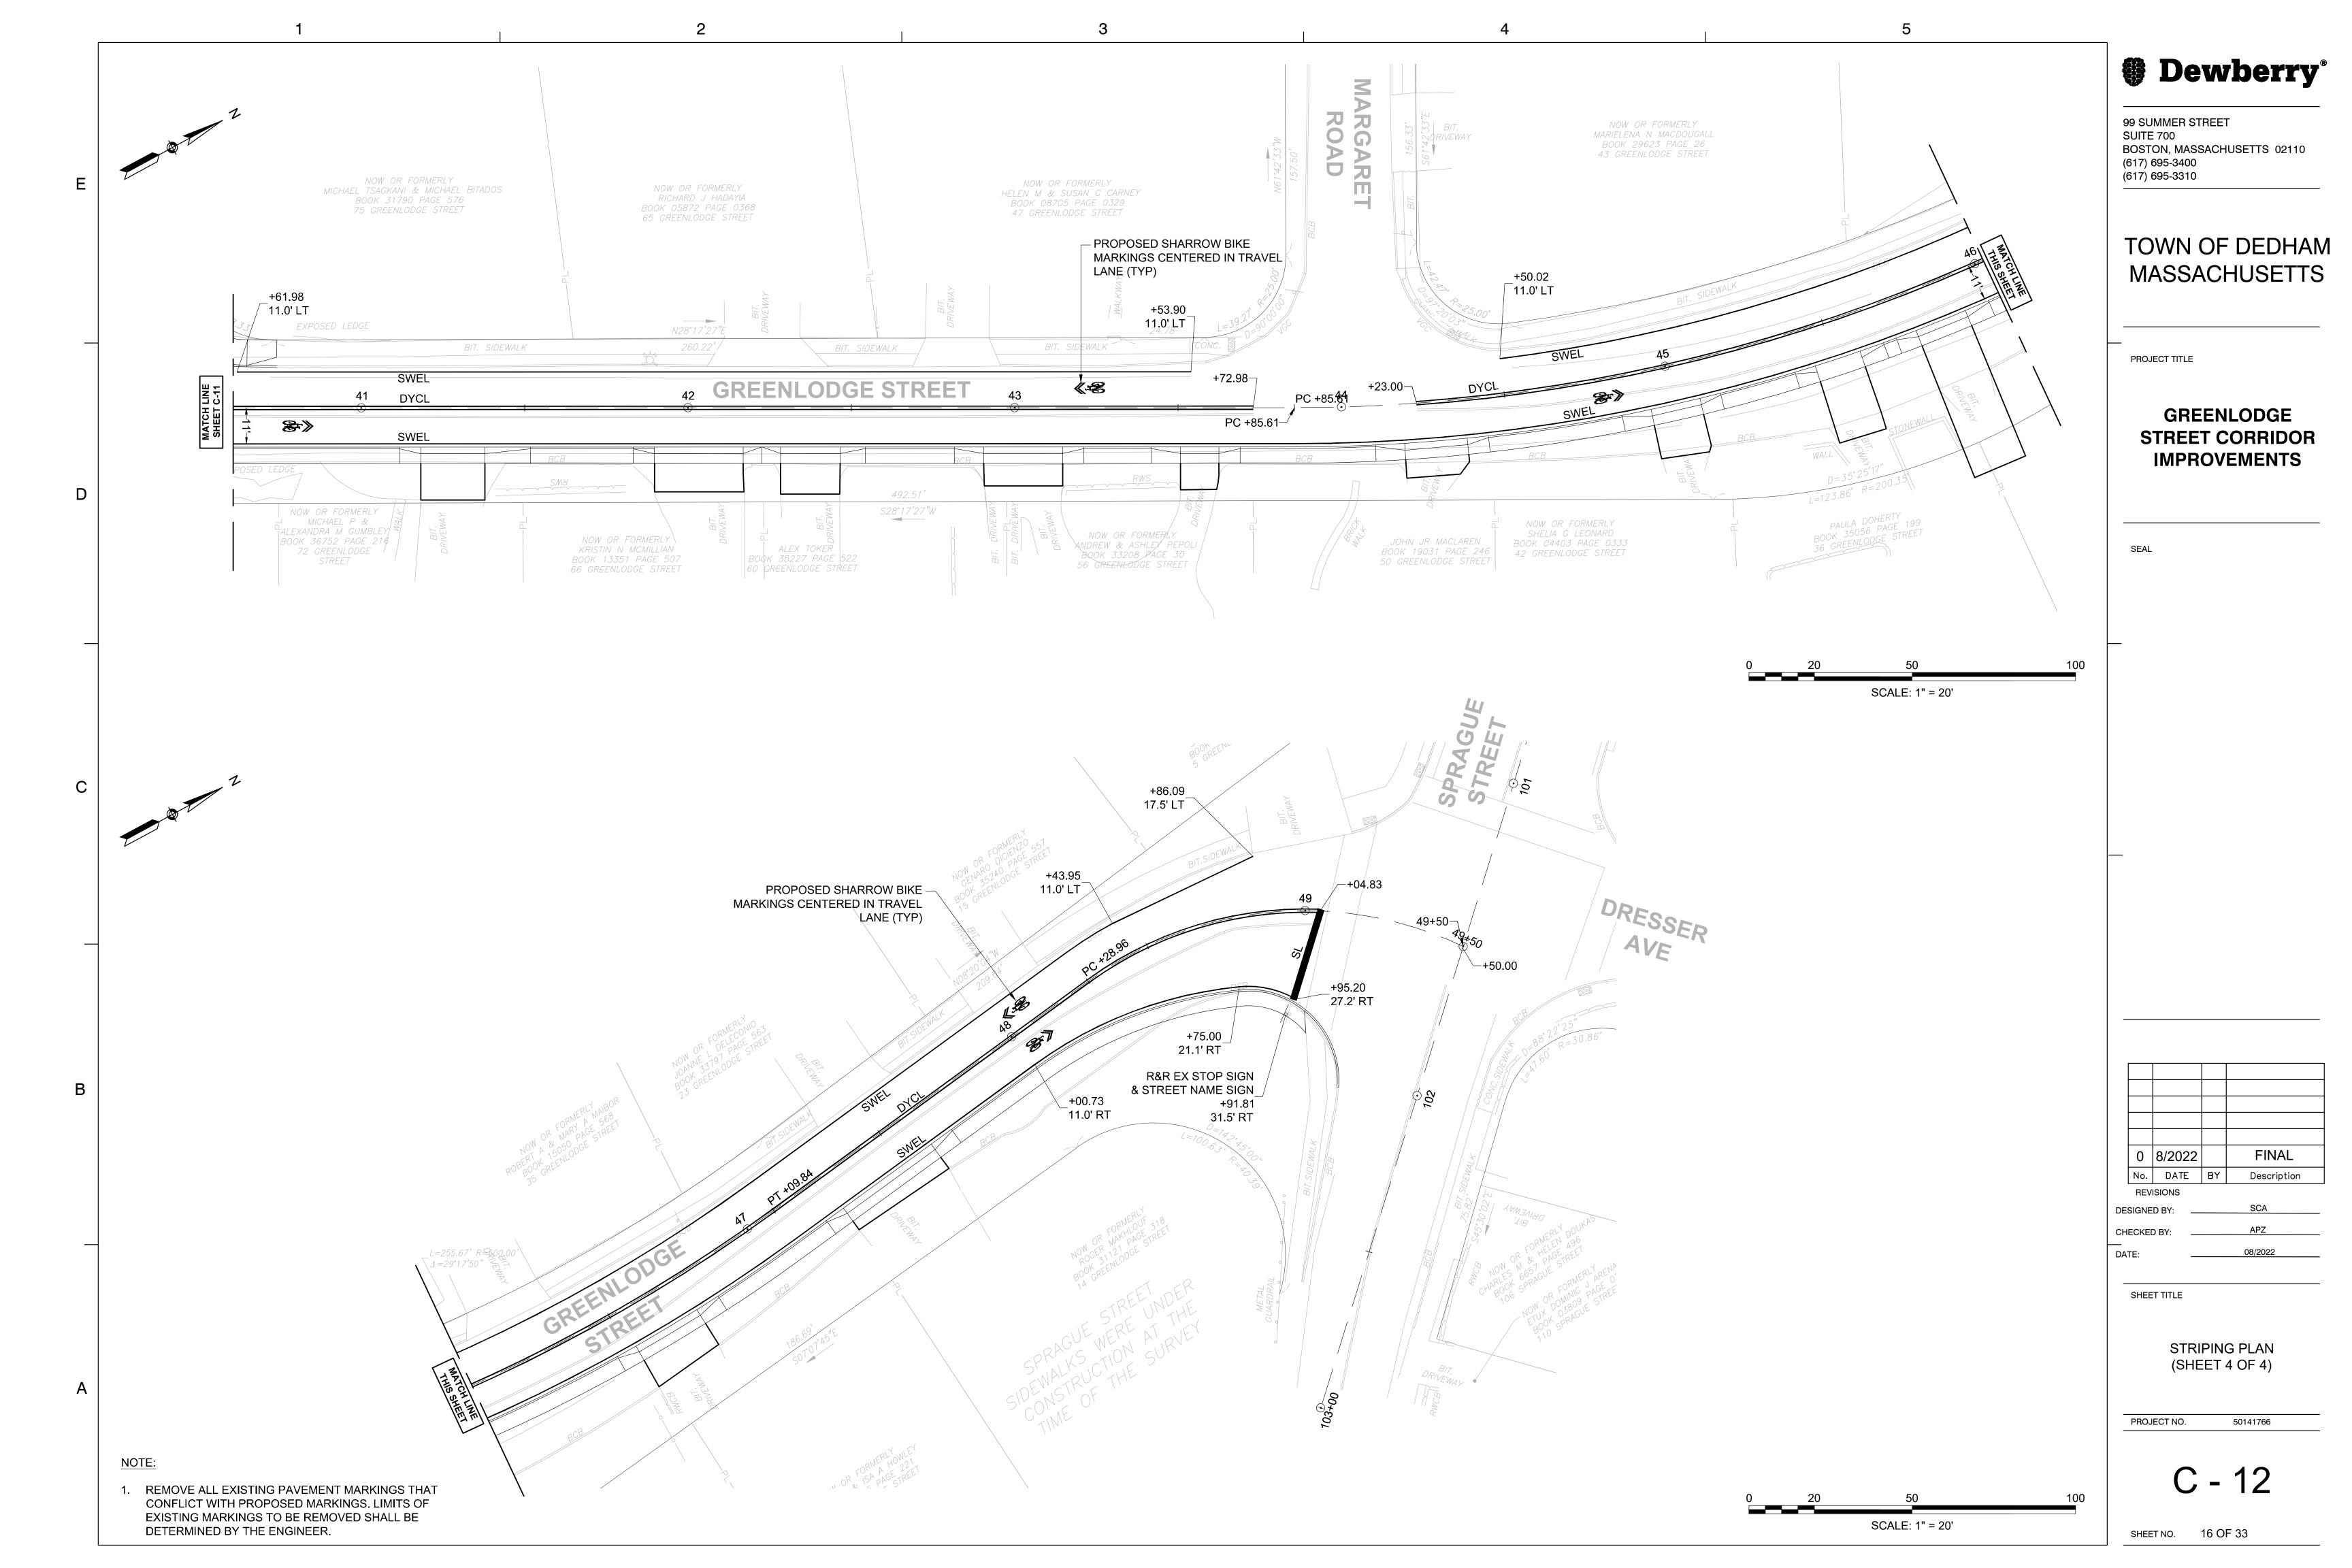












TEMPORARY TRAFFIC CONTROL NOTES

GENERAL

- 1. ALL TEMPORARY TRAFFIC CONTROL MEASURES SHALL CONFORM TO PART VI OF THE MANUAL ON UNIFORM TRAFFIC CONTROL DEVICES (M.U.T.C.D.) 2009 EDITION, SUPPLEMENTALS THERETO, THE STANDARD SPECIFICATIONS, AND THE FOLLOWING NOTES.
- 2. LANE RESTRICTIONS MAY NOT REMAIN OVERNIGHT OR DURING NON-WORKING HOURS. AFTER EACH WORKING DAY, TRAFFIC CONTROL DEVICES THAT ARE NOT REQUIRED SHALL BE MOVED OFF THE ROADWAY OR FULL DEPTH CONSTRUCTION AREA AND PLACED SO AS NOT TO IMPEDE PEDESTRIAN AREAS, ABUTTER ACCESS OR CAUSE CONFUSION TO MOTORISTS. IN CERTAIN CIRCUMSTANCES, AND ONLY WITH THE APPROVAL OF THE TOWN AND THE ENGINEER, CAN LANE RESTRICTIONS REMAIN OVERNIGHT.
- 3. CONTRACTOR SHALL PROVIDE A SAFE TEMPORARY PEDESTRIAN ACCESS WHERE EXISTING SIDEWALKS OR OTHER PEDESTRIAN AREAS ARE AFFECTED BY CONSTRUCTION WORK. CONTRACTOR SHALL MAINTAIN ABUTTER ACCESS AT ALL TIMES EXCEPT FOR SHORT PERIODS APPROVED BY THE ENGINEER.
- 4. CONTRACTOR SHALL PLACE ALL CONSTRUCTION SIGNING, TRAFFIC CONTROL DEVICES AND TEMPORARY PAVEMENT MARKING FOR EACH PHASE PRIOR TO COMMENCEMENT OF CONSTRUCTION.
- 5. ONE (1) THRU TRAVEL LANE HAVING A MINIMUM WIDTH OF 11'-0" SHALL BE PROVIDED FOR BOTH DIRECTIONS (LANE TO BE SHARED AND DIRECTION OF TRAVEL TO ALTERNATE IN SOME SITUATIONS UNDER POLICE OFFICER CONTROL) DURING ALL PHASES OF CONSTRUCTION AS SHOWN ON THE TEMPORARY TRAFFIC CONTROL PLANS, UNLESS OTHERWISE DIRECTED BY THE ENGINEER.
- 6. IN THE INTEREST OF PUBLIC SAFETY AND CONVENIENCE, THE TOWN MAY, WHEN WORK INFRINGES UPON THE TRAVELED WAY, RESTRICT THE CONTRACTOR'S WORKING HOURS.

UNLESS OTHERWISE NOTED, CONSTRUCTION METHODS, MATERIAL REQUIREMENTS AND METHOD OF MEASUREMENT SHALL BE IN ACCORDANCE WITH THE LATEST EDITION OF THE MASSACHUSETTS DEPARTMENT OF TRANSPORTATION (MassDOT) STANDARD SPECIFICATIONS.

ALSO REFERENCE CURRENT MassDOT CONSTRUCTION STANDARD DETAILS.





DEDHAM DPW DESIGN & CONSTRUCTION STANDARDS

TEMPORARY TRAFFIC CONTROL NOTES

SCALE:	DATE OF ISSUE:
NTS	AUGUST 2015
REVISED:	
DETAIL N	UMBER:

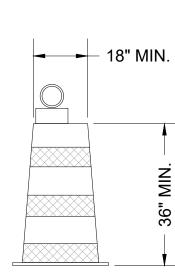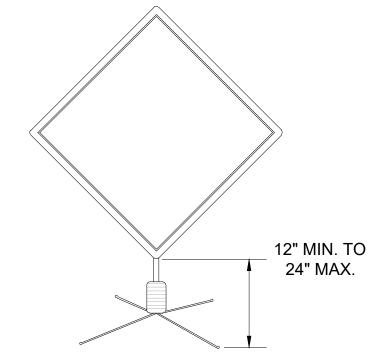TM.01





PORTABLE TRAFFIC DRUM

TYPICAL WARNING SIGN

				CONST	RUC	TION S	SIGN	SUM	IMARY	/ TAE	BLE			
		DTH :HES)			TEXT DIN	MENSIONS	(INCHES)			COLOR				
I.D. #	WIDTH	HEIGHT	TEXT	IMAGE	LETTER HEIGHT	VERT. SPACING	ARROW RTE. MKR.	# OF SIGNS REQ'D	BACK- GROUND	TEXT	BORDER	POST SIZE & # REQ'D	UNIT AREA (SQ. FT.)	AREA (SQ. FT.)
W1-4L	36	x 36	N/A					1	ORANGE	BLACK	BLACK		9	9
W20-1	36	x 36	ROAD WORK AHEAD	ROAD WORK AHEAD				10	ORANGE	BLACK	BLACK		9	99
W20-4	36	x 36	ONE LANE ROAD AHEAD	ONE LANE ROAD AHEAD				4	ORANGE	BLACK	BLACK		9	36
W20-7A	36	x 36	N/A		F	PER MUTCE)	4	ORANGE	BLACK	BLACK	MOUNTED ON (1) TEMPORARY SUPPORT	9	36
R4-7	24	30	N/A					1	WHITE	BLACK	BLACK		5	5
R4-8	24	30	N/A					1	WHITE	BLACK	BLACK		5	5
G20-2	36	18	END ROAD WORK	END ROAD WORK				5	ORANGE	BLACK	BLACK		4.5	22.5

TRAFFIC MANAGEMENT NOTES:

- 1. ALL TEMPORARY TRAFFIC CONTROL SIGNS AND DEVICES SHALL CONFORM TO THE LATEST EDITION OF THE "MANUAL ON UNIFORM TRAFFIC CONTROL DEVICES" (MUTCD) AND ALL REVISIONS.
- 2. ALL SIGNS, LEGENDS, AND BORDERS SHALL BE IN ACCORDANCE WITH THE MUTCD.
- 3. TEMPORARY CONSTRUCTION SIGNING AND OTHER TRAFFIC CONTROL DEVICES SHALL BE IN PLACE PRIOR TO THE START OF WORK.
- 4. TEMPORARY CONSTRUCTION SIGNING, BARRICADES AND ALL OTHER NECESSARY WORK ZONE TRAFFIC CONTROL DEVICES SHALL BE REMOVED FROM THE HIGHWAY OR COVERED WHEN NOT REQUIRED FOR CONTROL OF TRAFFIC. ALL WORK ZONES OUTLINED HEREIN THAT ARE CONTROLLED BY FLAGGERS SHALL BE ADJUSTED SUCH THAT TWO-WAY TRAVEL IN-LINE WITH EXISTING FACILITIES IS PROVIDED WHEN FLAGGERS ARE NOT PRESENT.
- 5. SIGNS AND SIGN SUPPORTS LOCATED ON OR NEAR THE TRAVELED WAY, AND REFLECTORIZED DRUMS WITH LIGHTING DEVICES MOUNTED ON THEM MUST PASS THE CRITERIA SET FORTH IN NCHRP REPORT 350, "RECOMMENDED PROCEDURES FOR THE SAFETY PERFORMANCE EVALUATION OF HIGHWAY FEATURES".
- 6. ABUTTER ACCESS SHALL BE MAINTAINED UNLESS OTHERWISE DIRECTED BY THE TOWN OF ACTON.
- 7. THE FIRST THREE PLASTIC DRUMS OF A TAPER MAY BE MOUNTED WITH TYPE A LIGHTS.
- 8. THE ADVISORY SPEED LIMIT, IF REQUIRED, SHALL BE DETERMINED BY THE ENGINEER
- 9. DISTANCES ARE A GUIDE AND MAY BE ADJUSTED IN THE FIELD BY THE ENGINEER
- 10. MAXIMUM SPACING OF TRAFFIC DEVICES IN A TAPER (DRUMS OR CONES) IS 20 FEET UNLESS SHOWN OTHERWISE ON THE PLANS.
- 11. MINIMUM LANE WIDTH IS TO BE 11 FEET UNLESS OTHERWISE SHOWN. MINIMUM LANE WIDTH TO BE MEASURED FROM THE BASE OF DRUMS OR BARRIERS.
- 12. ALL SIGNS SHALL BE MOUNTED ON THEIR OWN STANDARD SIGN SUPPORTS.
- 13. OPEN TRENCHES NOT PROTECTED BY CONCRETE BARRICADES SHALL BE TEMPORARILY BACKFILLED OR COVERED WITH ONE (1) INCH THICK STEEL PLATES AT THE CLOSE OF EACH WORK DAY. AT LEAST 20% OF THE PLATE SHALL BE SUPPORTED ON EXISTING GROUND.
- 14. FLAGGER AHEAD SIGNS (W20-7A) SHALL BE USED IN ADVANCE OF ANY POINT AT WHICH A FLAGGER HAS BEEN STATIONED TO CONTROL TRAFFIC. THE SIGN SHALL BE PROMPTLY REMOVED OR COVERED WHENEVER THE FLAGGER IS NOT AT THE STATION.
- 15. TEMPORARY CONSTRUCTION SIGNS AND OTHER WORKZONE TRAFFIC CONTROL DEVICES THAT ARE DAMAGED OR REQUIRE RELOCATION SHALL BE REPLACED AND/OR RELOCATED AS DIRECTED BY THE ENGINEER.
- 16. CONTRACTOR SHALL NOTIFY EACH ABUTTER AT LEAST 24 HOURS IN ADVANCE OF THE START OF ANY WORK THAT WILL REQUIRE THE TEMPORARY CLOSURE OF DRIVEWAY OR SIDEWALK ACCESS TO THEIR PROPERTY.

Dewberry*

99 SUMMER STREET SUITE 700

BOSTON, MASSACHUSETTS 02110 (617) 695-3400 (617) 695-3310

TOWN OF DEDHAM MASSACHUSETTS

PROJECT TITLE

GREENLODGE STREET CORRIDOR IMPROVEMENTS

SEAL

0 8/2022 FINAL

No. DATE BY Description

REVISIONS

DESIGNED BY: SCA

CHECKED BY: APZ

DATE: ______08/20

SHEET TITLE


TRAFFIC MANAGEMENT PLANS & DETAILS


(SHEET 1 OF 2)


PROJECT NO. 50141766

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SHEET NO. 17 OF 33



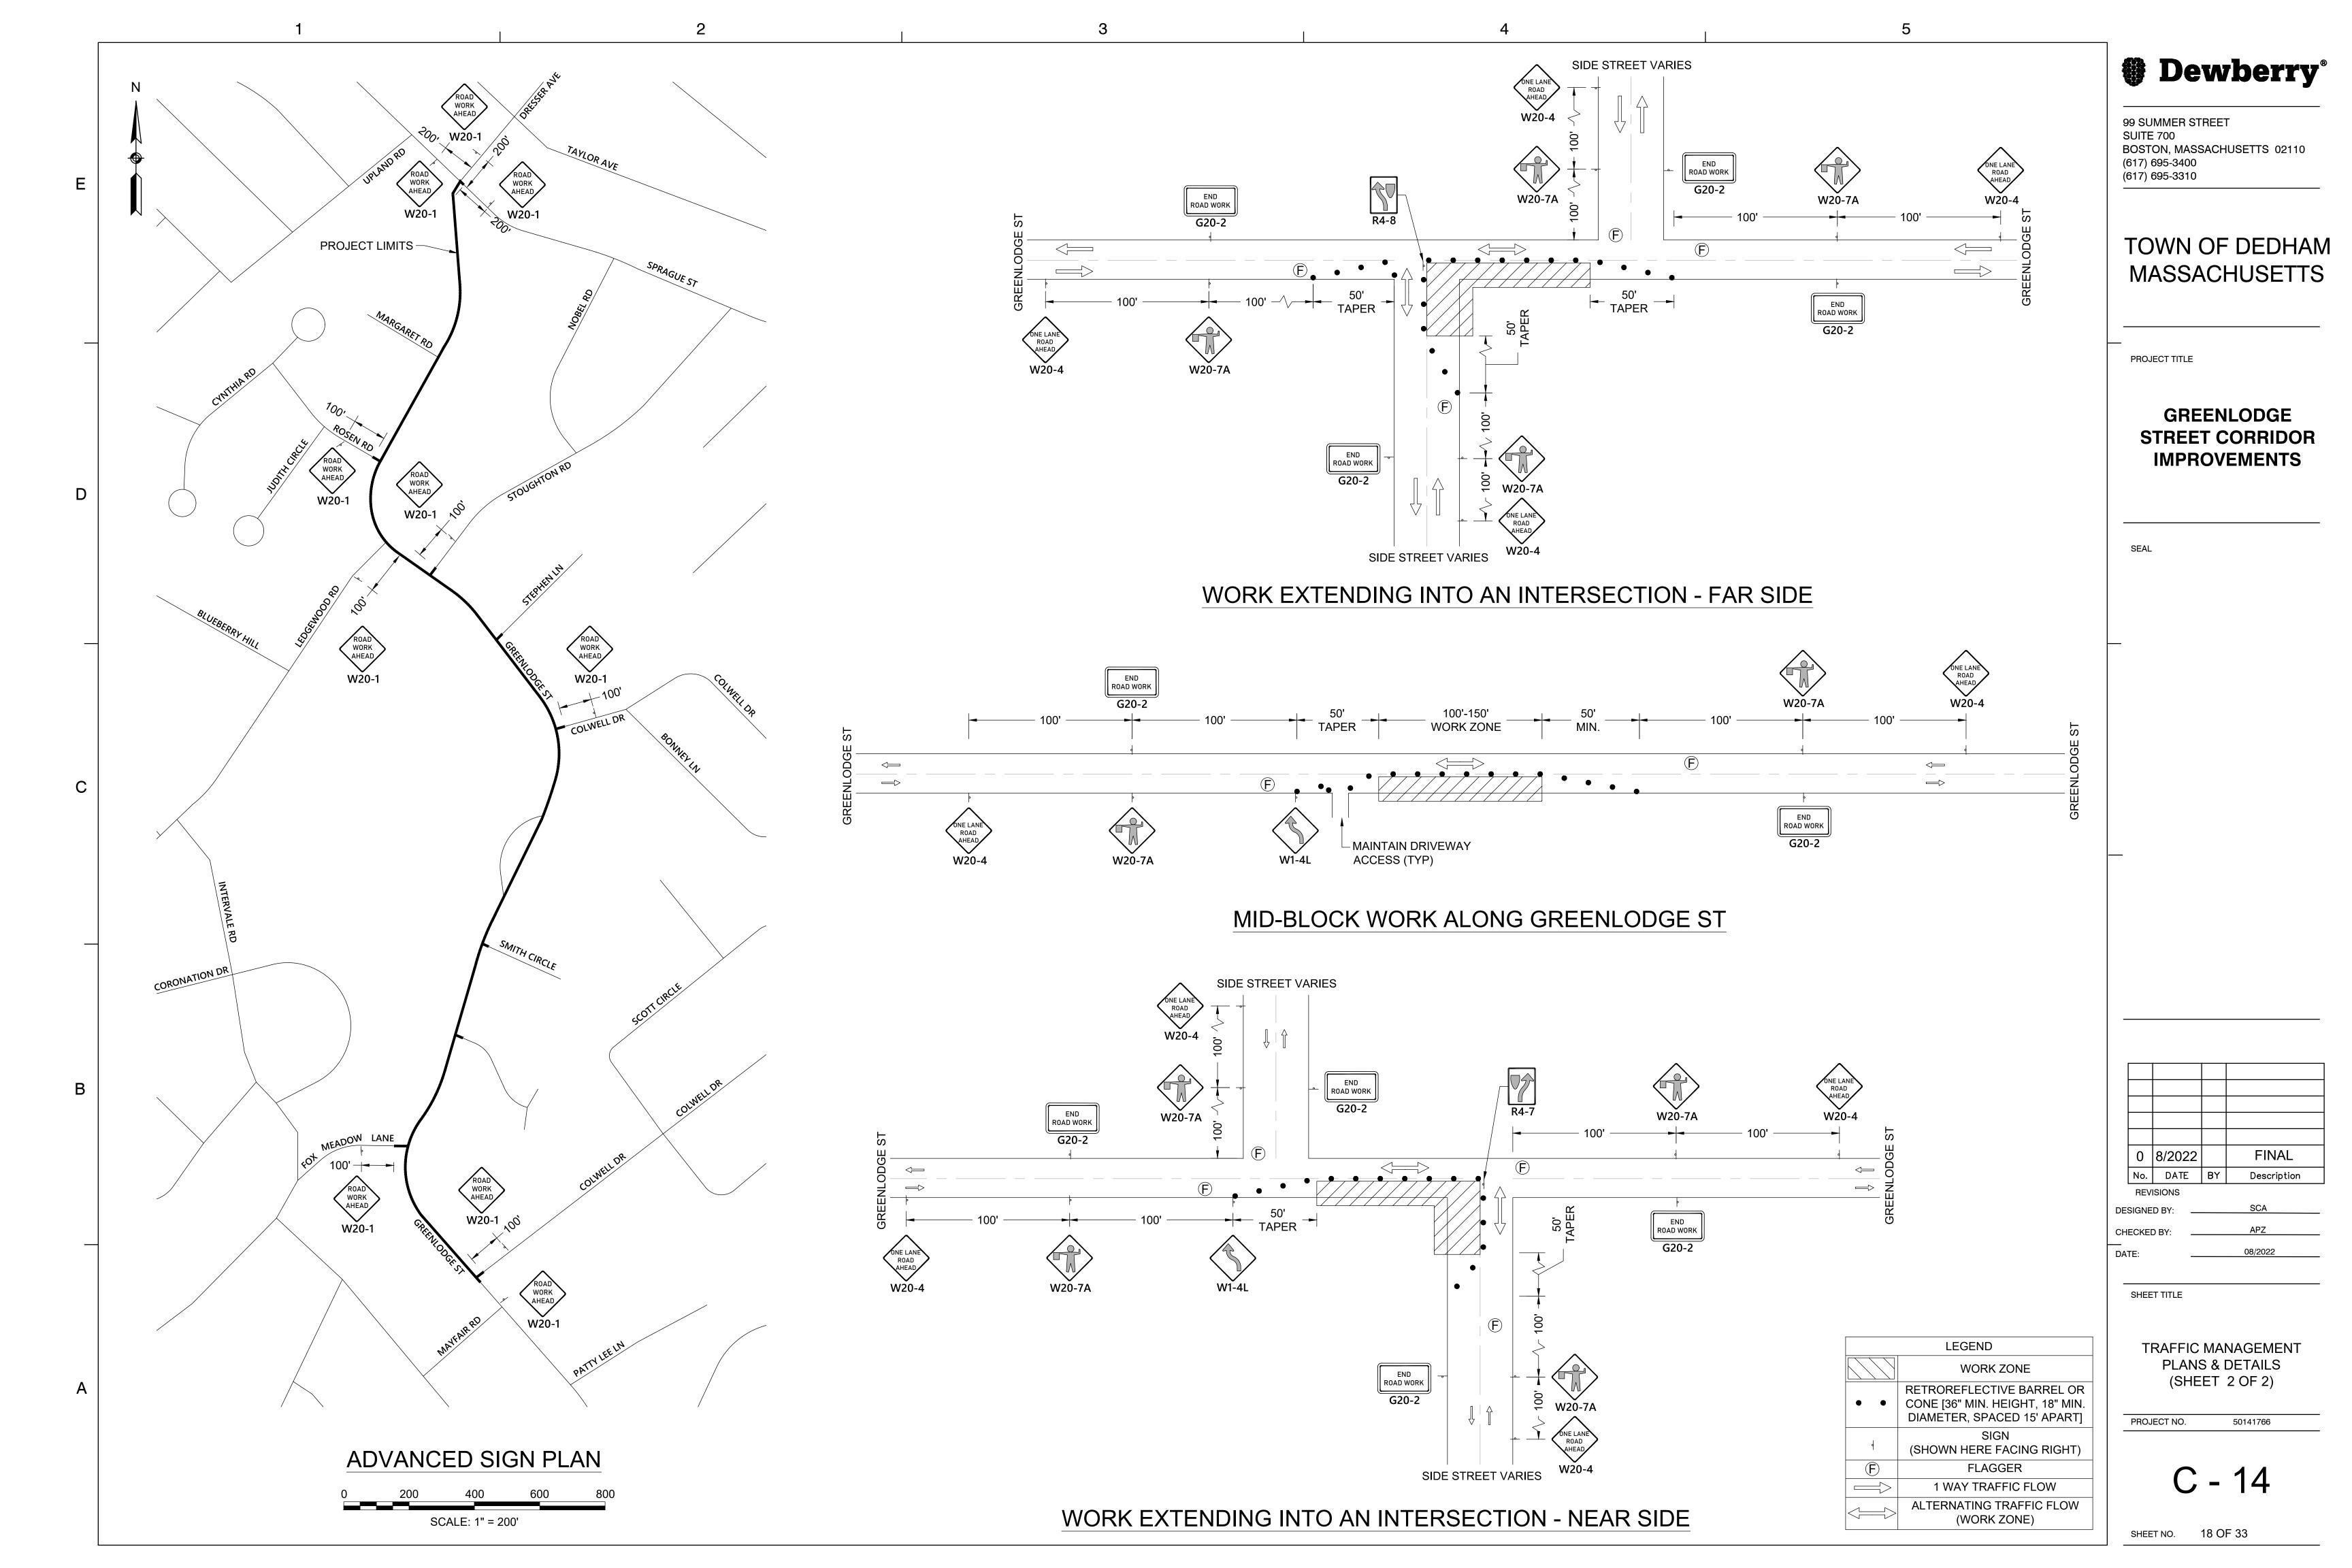

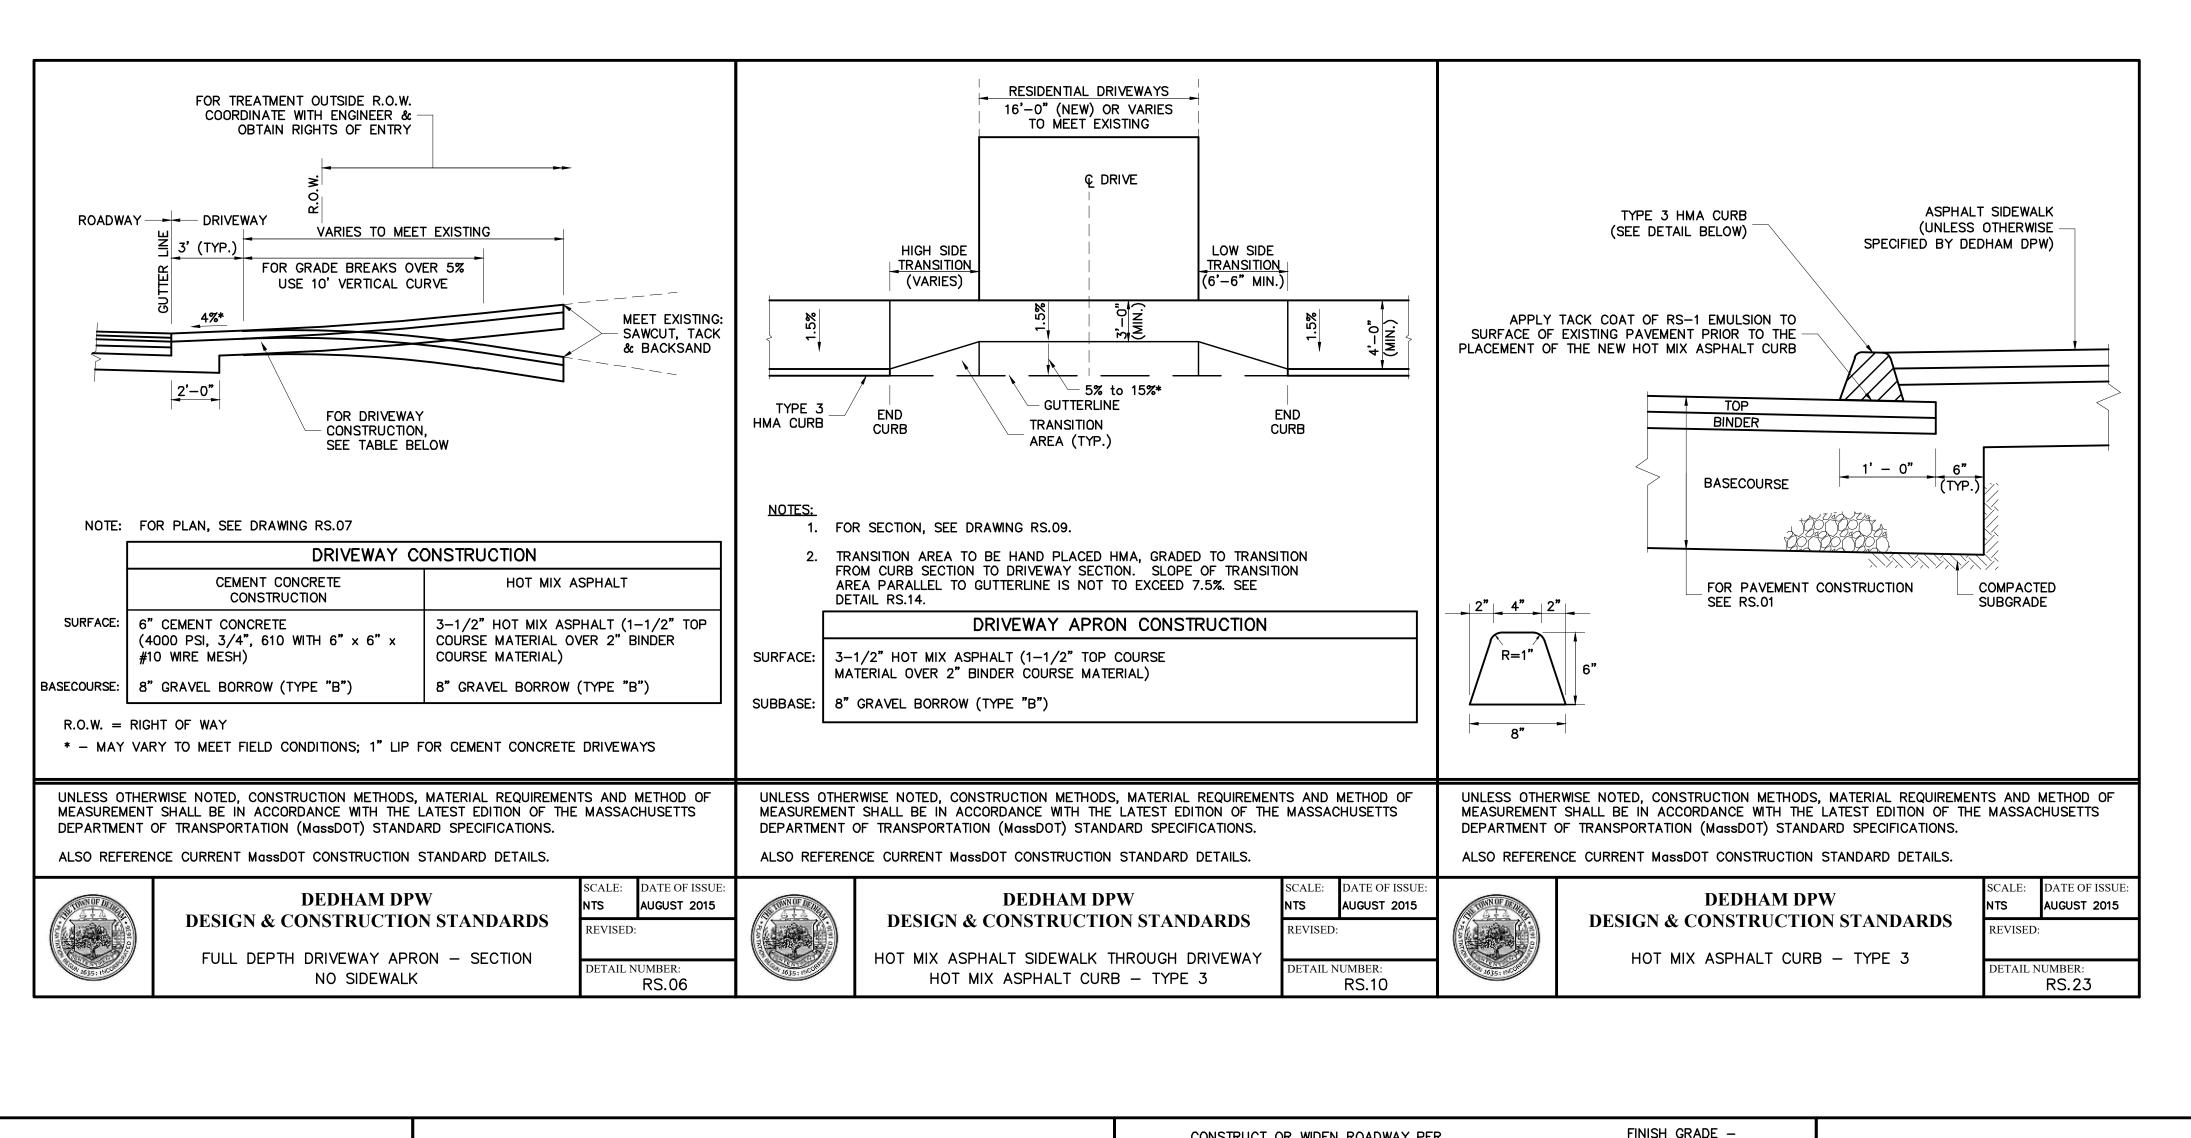

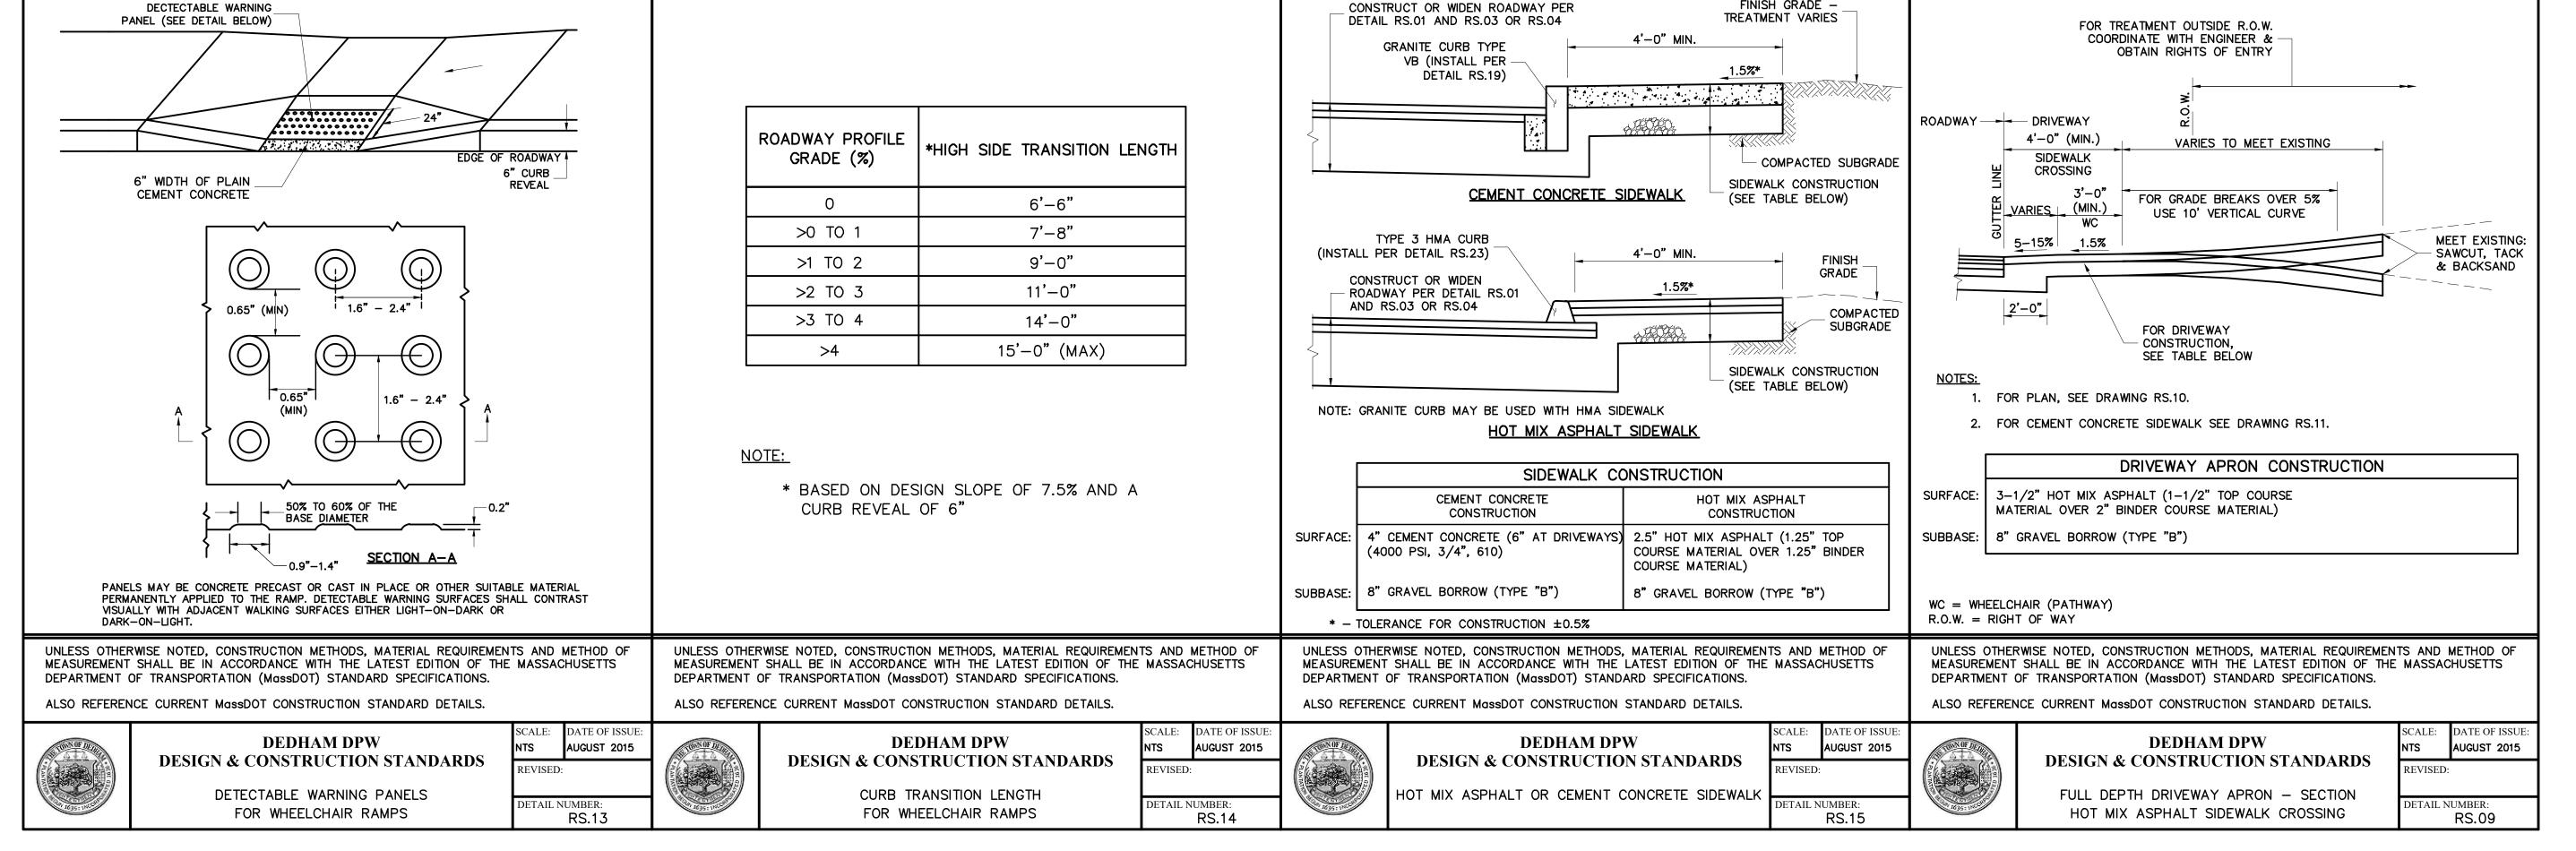

99 SUMMER STREET SUITE 700

BOSTON, MASSACHUSETTS 02110 (617) 695-3400 (617) 695-3310

TOWN OF DEDHAM MASSACHUSETTS

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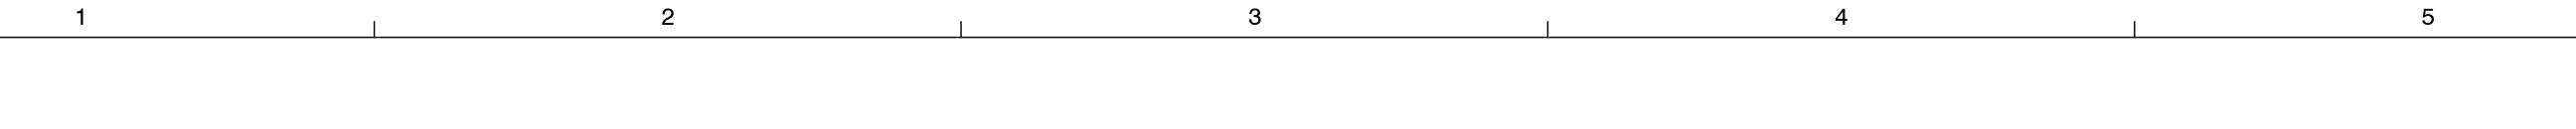
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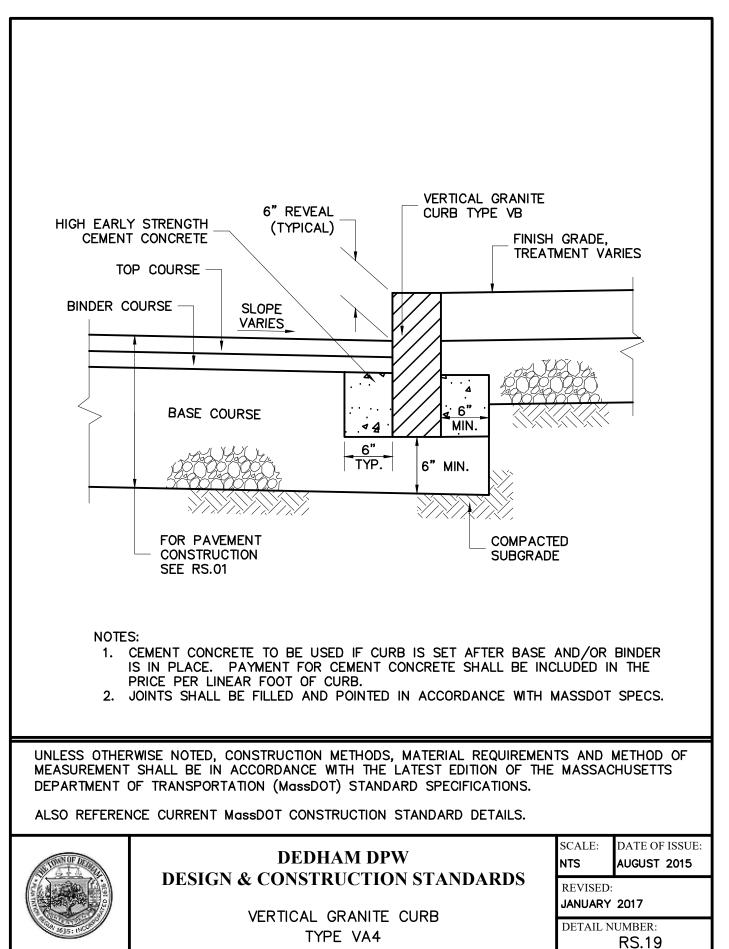
DEDHAM STANDARD DETAILS (SHEET 1 OF 4)


PROJECT NO. 50141766


C - 15

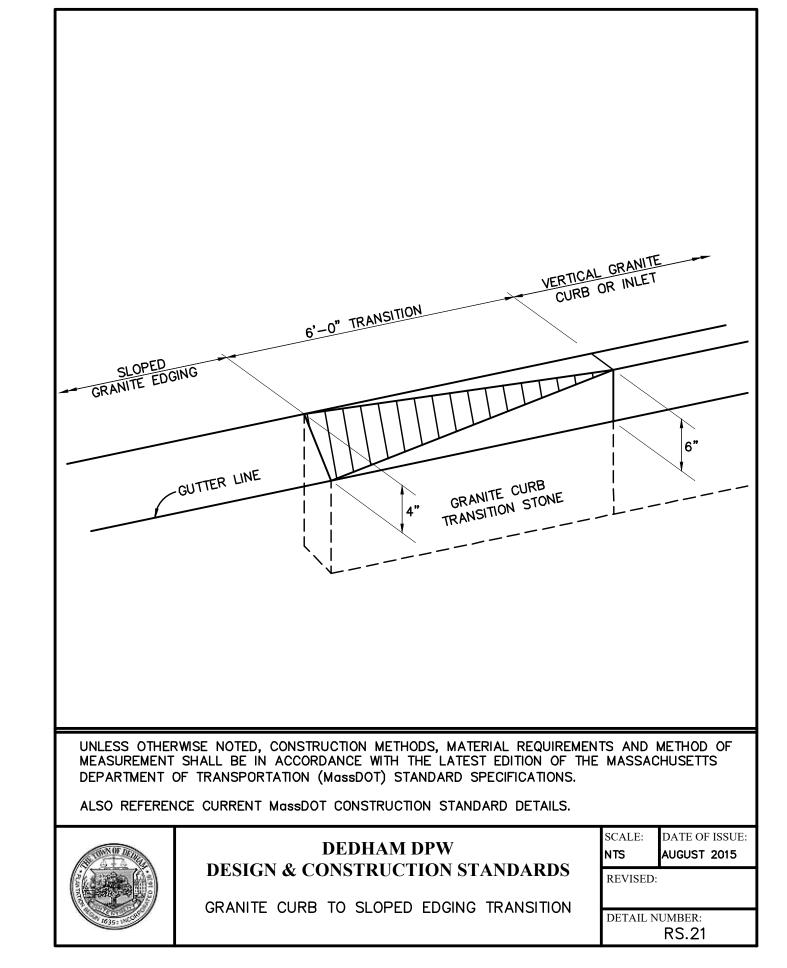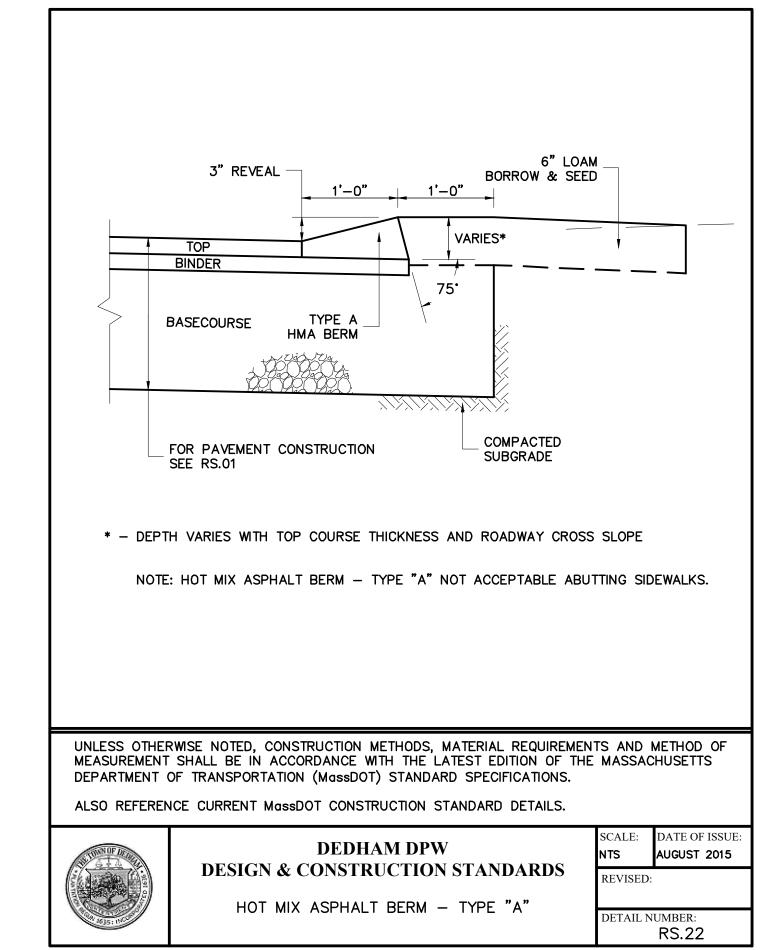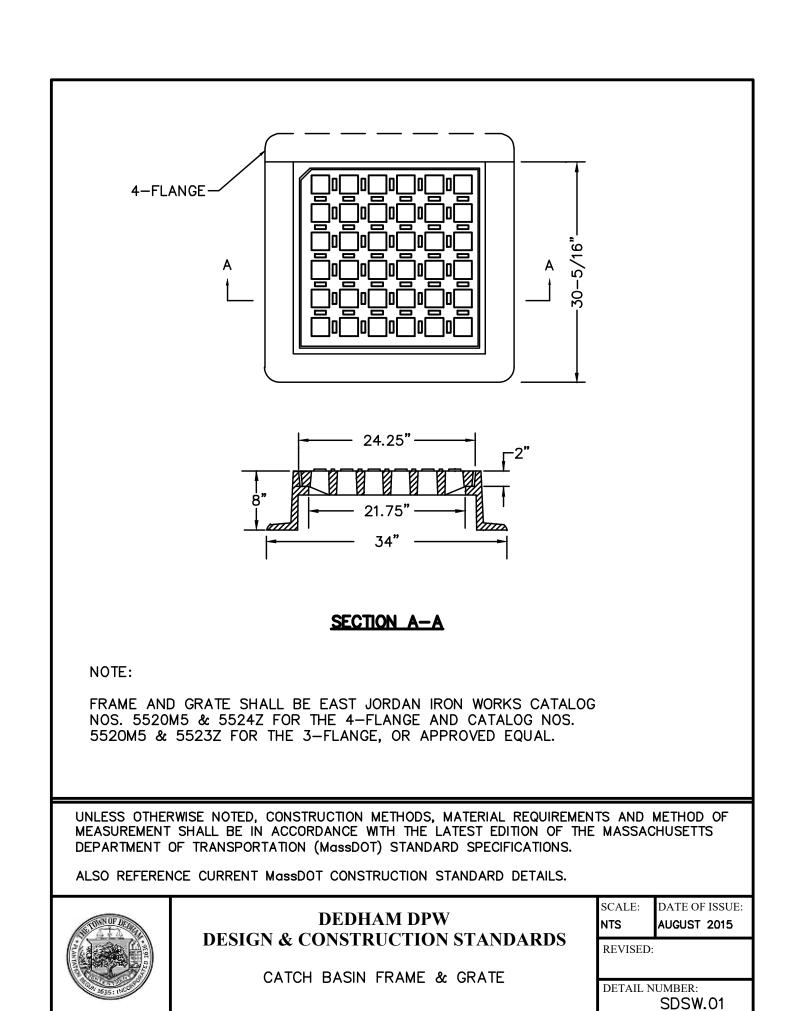
SHEET NO. 19 OF 33

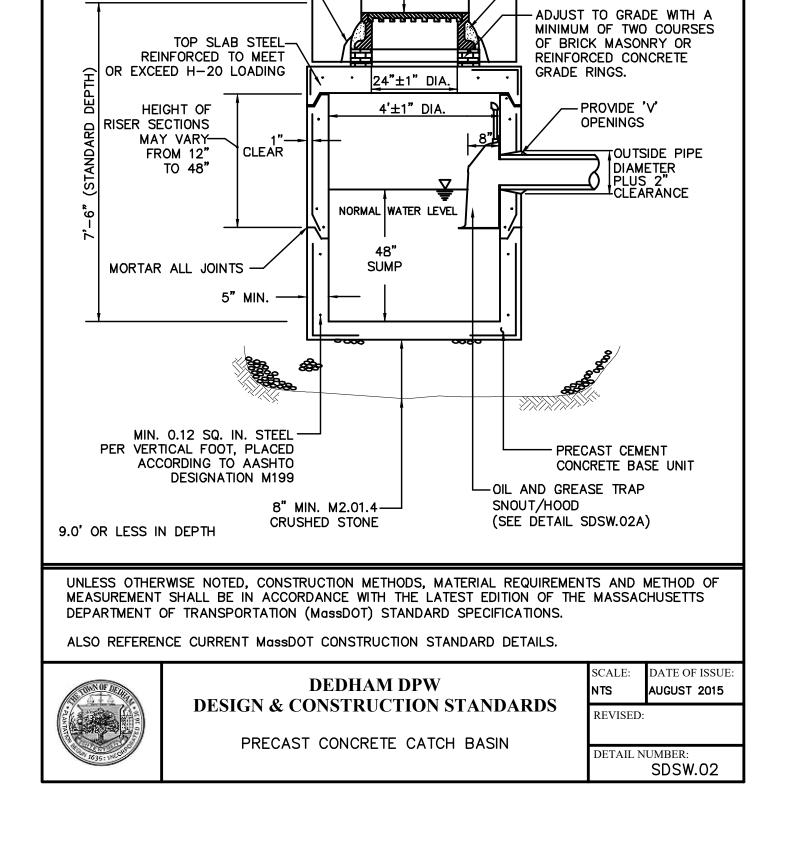













GRANITE CURB INLET -

SEAL ALL BRICK WORK-

FRAME AND GRATE SHALL BE EAST JORDAN IRON WORKS CATALOG NOS. 5520M5 & 5523Z

— FRAME TO BE SET IN FULL BED OF MORTAR

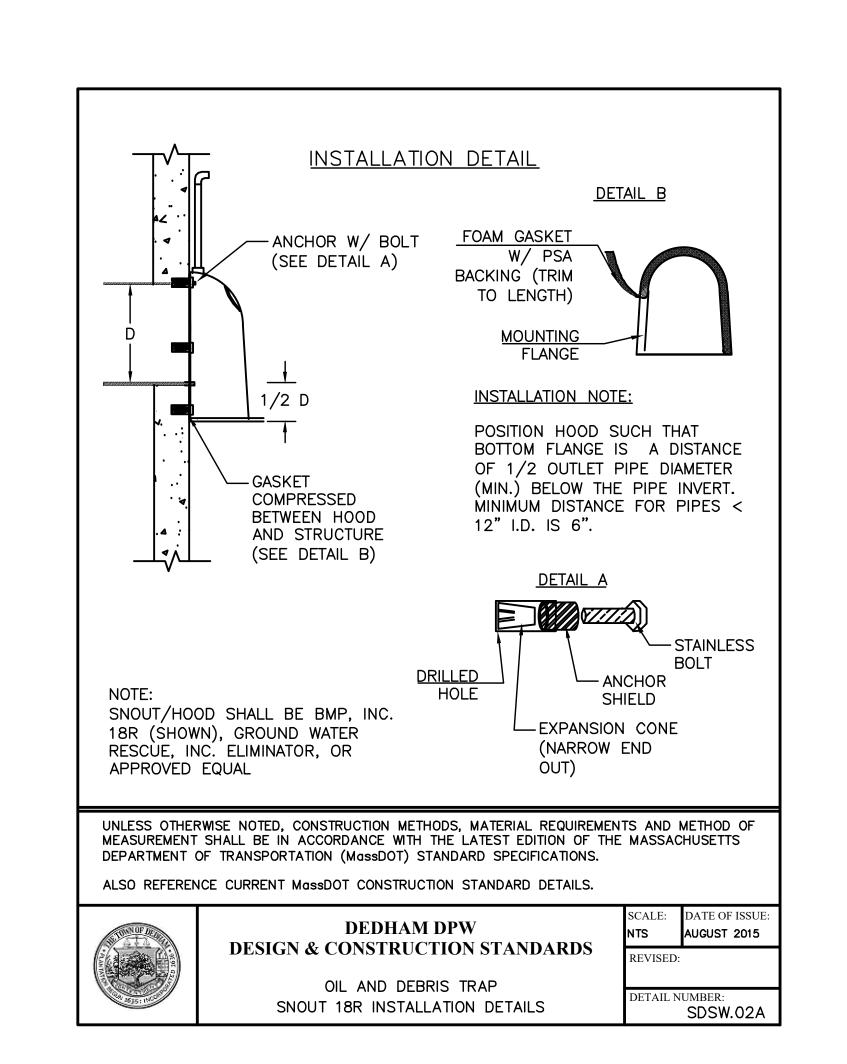(3-FLANGE), OR APPROVED EQUAL





99 SUMMER STREET SUITE 700 BOSTON, MASSACHUSETTS 02110 (617) 695-3400

TOWN OF DEDHAM MASSACHUSETTS

PROJECT TITLE

(617) 695-3310

GREENLODGE STREET CORRIDOR IMPROVEMENTS

SEAL

0 8/2022 FINAL
No. DATE BY Description
REVISIONS

DESIGNED BY:

CHECKED BY:

APZ

DATE:

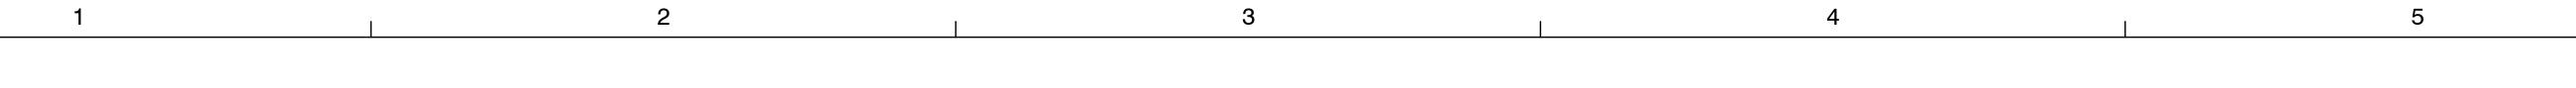
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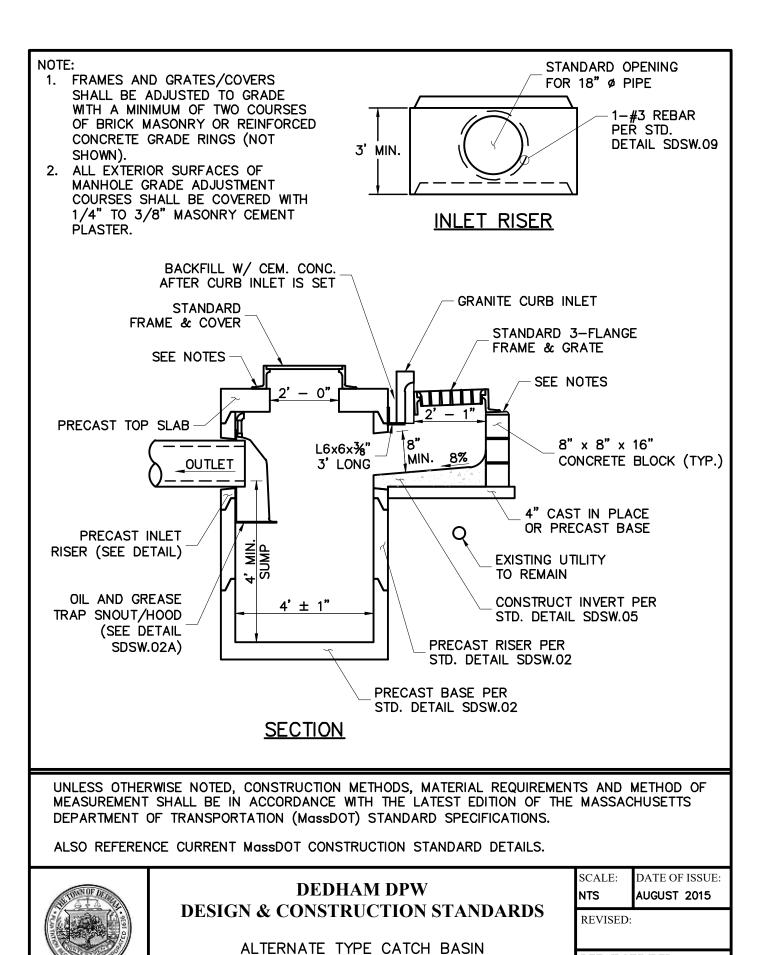
DEDHAM STANDARD
DETAILS
(SHEET 2 OF 4)

PROJECT NO. 50141766

C - 16

SHEET NO. 20 OF 33

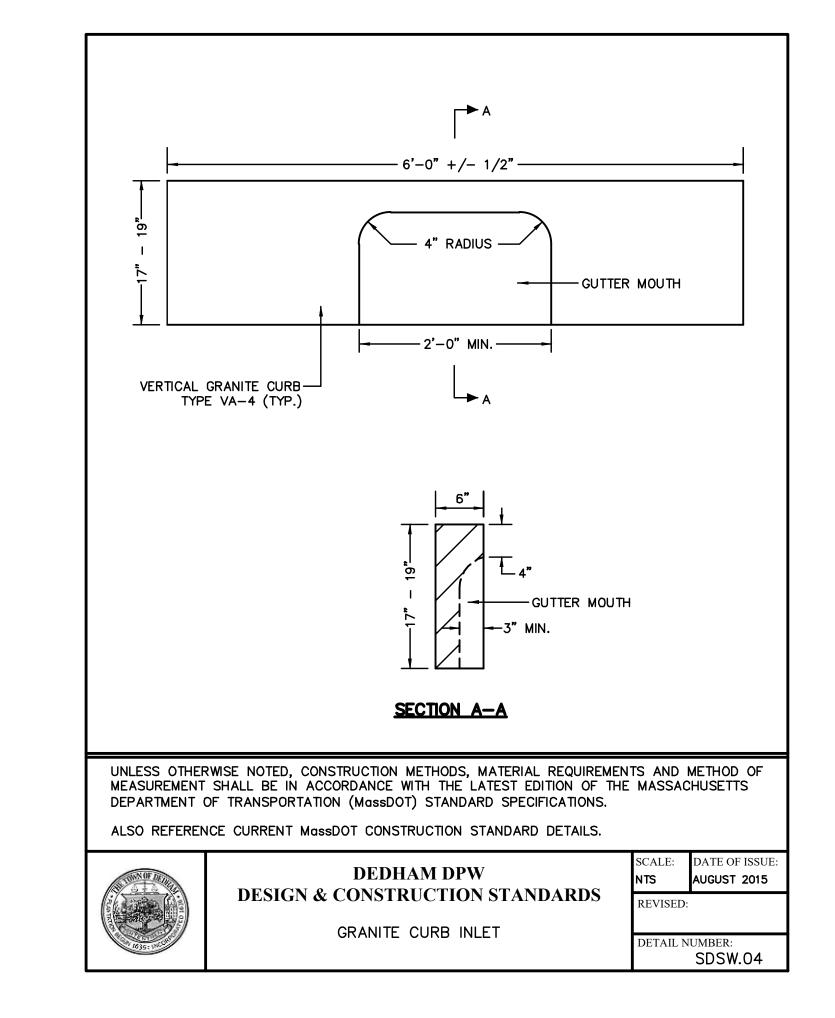


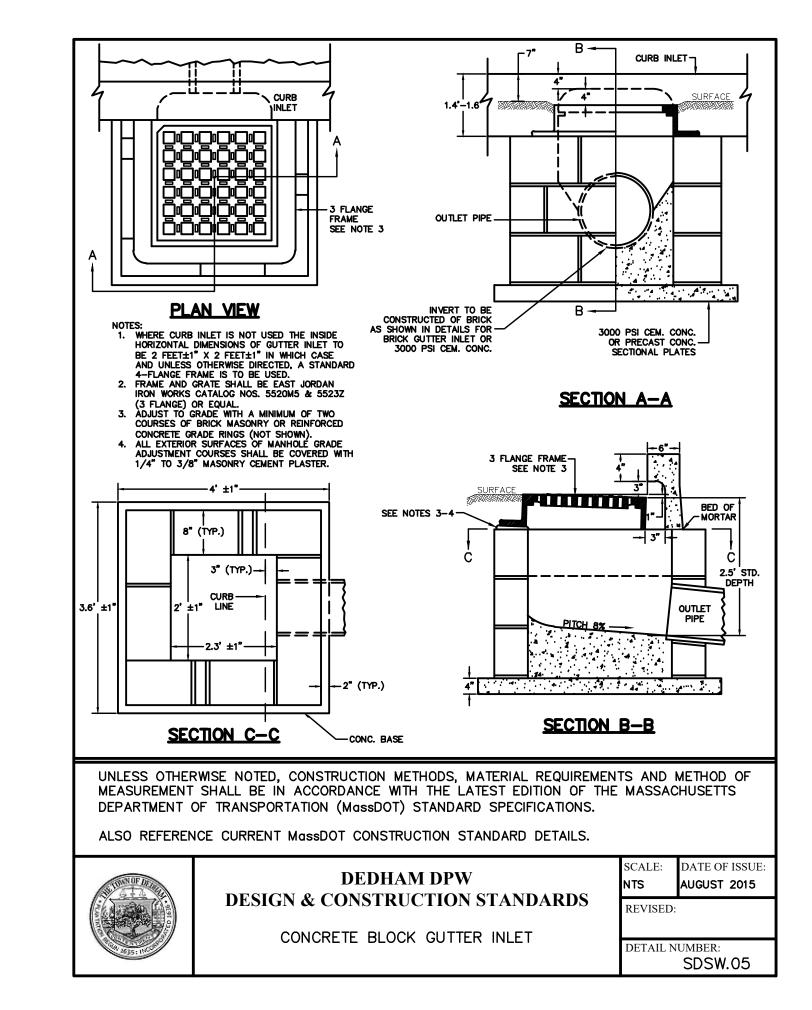


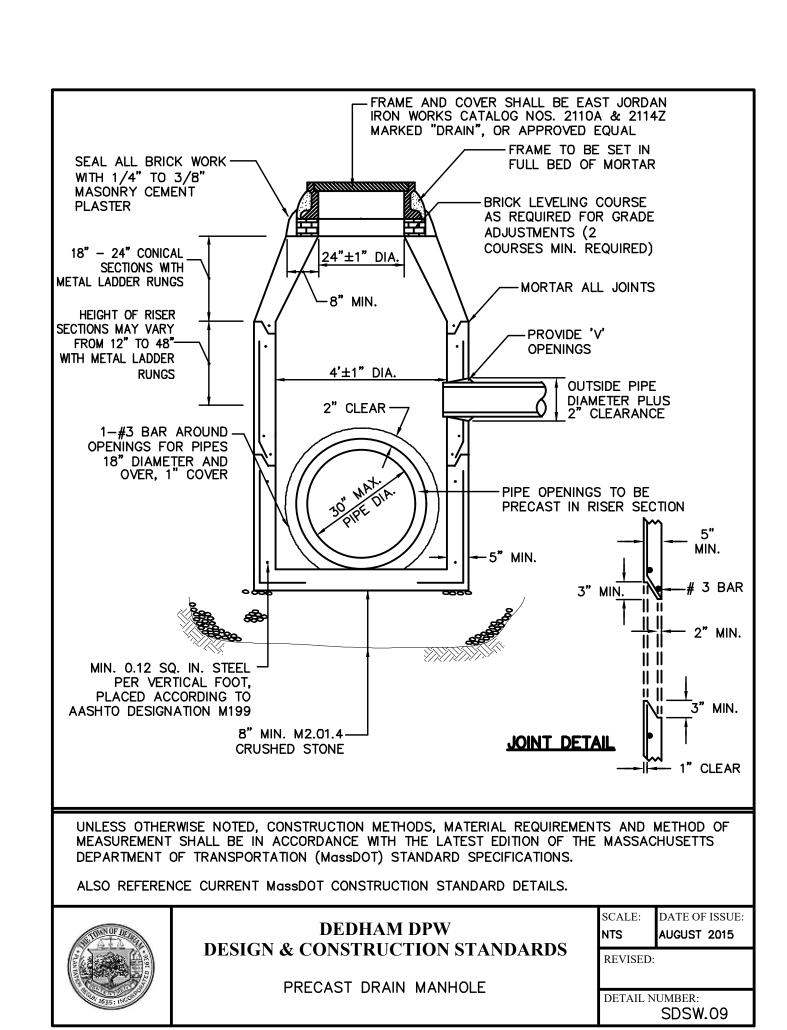
SECTION

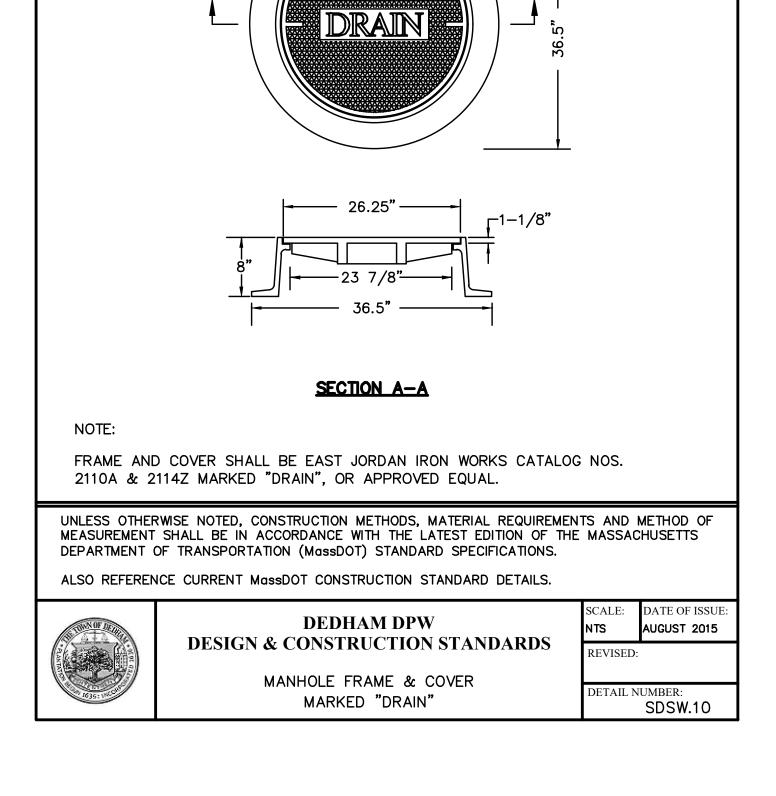
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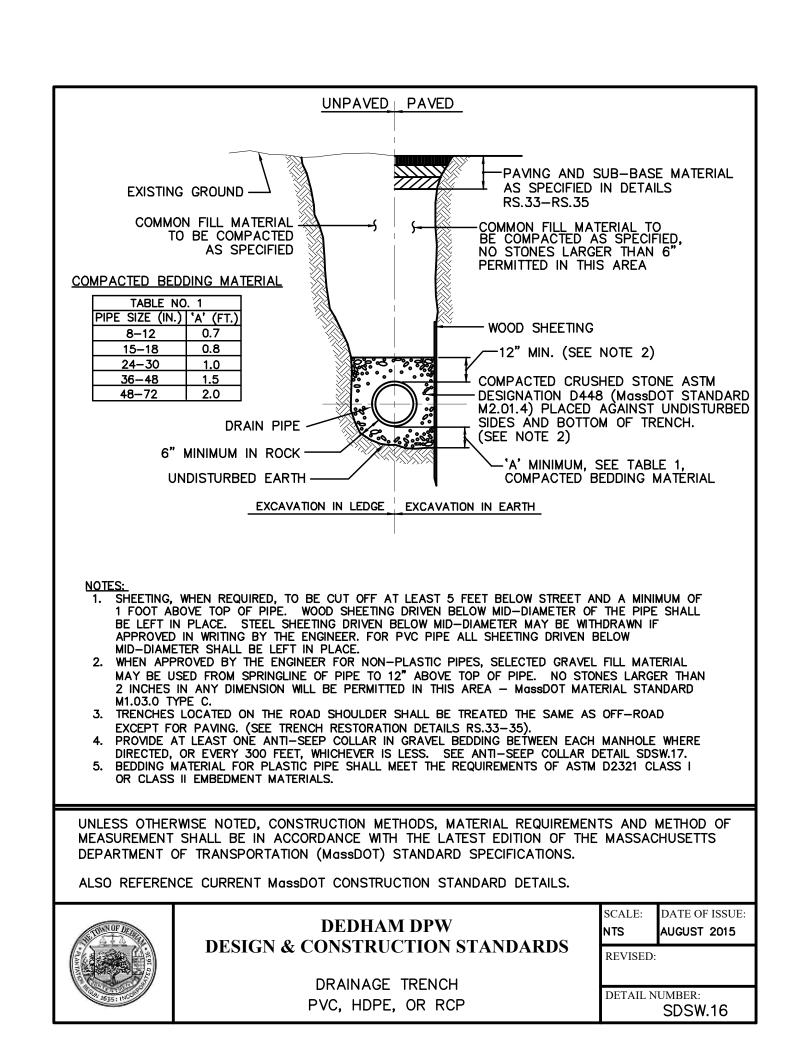
SDSW.03













99 SUMMER STREET SUITE 700

BOSTON, MASSACHUSETTS 02110 (617) 695-3400 (617) 695-3310

TOWN OF DEDHAM MASSACHUSETTS

PROJECT TITLE

GREENLODGE STREET CORRIDOR IMPROVEMENTS

SEAL

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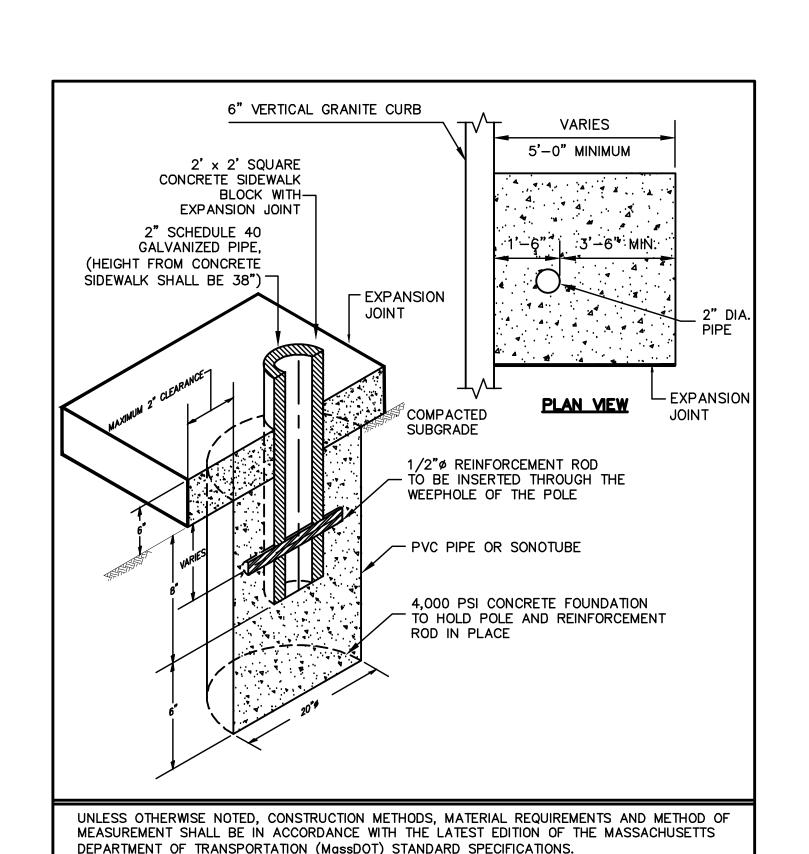
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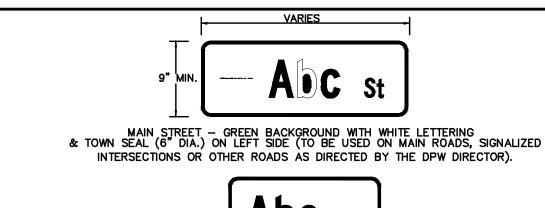
DEDHAM STANDARD
DETAILS
(SHEET 3 OF 4)

PROJECT NO. 50141766

C - 17

SHEET NO. 21 OF 33





INTERSECTIONS OR OTHER ROADS AS DIRECTED BY THE DPW DIRECTOR).



PUBLIC WAY MINOR STREET - GREEN BACKGROUND WITH WHITE LETTERING



PRIVATE WAY - BLUE BACKGROUND WITH WHITE LETTERING

ADC st DR

PRIVATE DRIVE - BROWN BACKGROUND WITH WHITE LETTERING

NOTES:

- 1. LETTERING ON SIGNS SHOULD CONSIST OF HIGHWAY B (MIN.) LETTERING WITH INITIAL UPPER-CASE LETTERS AT LEAST 6" IN HEIGHT AND LOWER-CASE LETTERS AT LEAST 4.5" IN
- 2. SUPPLEMENTARY LETTERING (i.e., St, Rd, Dr, etc) SHOULD CONSIST OF HIGHWAY B LETTERING WITH INITIAL UPPER-CASE LETTERS AT LEAST 3" IN HEIGHT AND LOWER-CASE LETTERS AT LEAST 2.25" IN HEIGHT.
- 3. ABBREVIATIONS FOR PRIVATE WAYS (PVT WAY) AND PRIVATE DRIVES (PVT DR) SHOULD CONSIST OF HIGHWAY B LETTERING ALL IN UPPER-CASE LETTERS AT LEAST 3" IN HEIGHT. 4. LETTER SPACING SHOULD BE IN CONFORMANCE WITH THE LATEST EDITION OF THE M.U.T.C.D.

UNLESS OTHERWISE NOTED, CONSTRUCTION METHODS, MATERIAL REQUIREMENTS AND METHOD OF MEASUREMENT SHALL BE IN ACCORDANCE WITH THE LATEST EDITION OF THE MASSACHUSETTS DEPARTMENT OF TRANSPORTATION (MassDOT) STANDARD SPECIFICATIONS.

ALSO REFERENCE CURRENT MassDOT CONSTRUCTION STANDARD DETAILS.



DATE OF ISSUE

AUGUST 2015


MISC.02

DETAIL NUMBER:

DEDHAM DPW DESIGN & CONSTRUCTION STANDARDS

TOWN STREET SIGNS

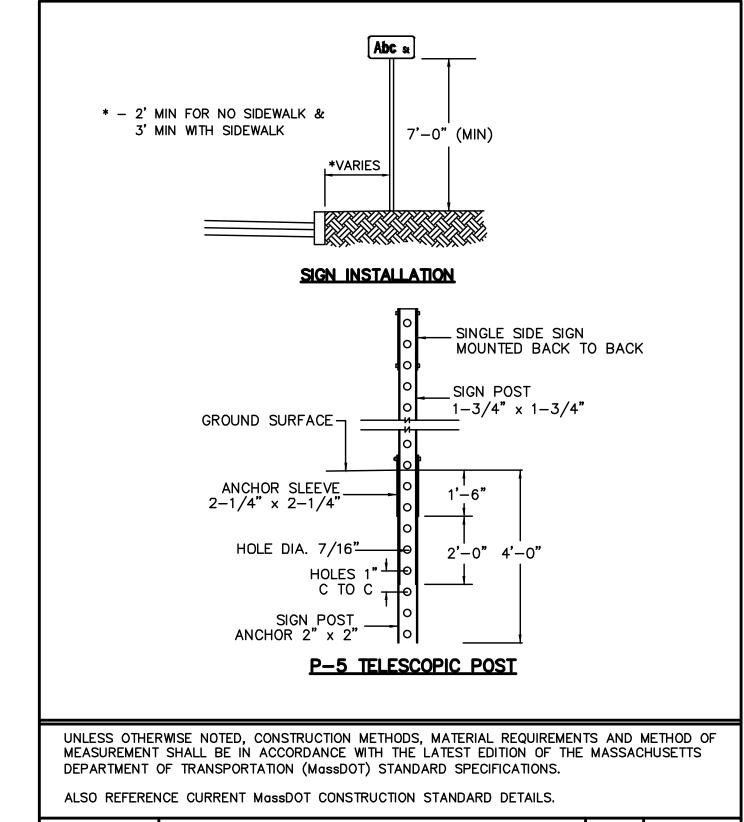SCALE: DATE OF ISSUE AUGUST 2015 EVISED: DETAIL NUMBER: MISC.05





DEDHAM DPW DESIGN & CONSTRUCTION STANDARDS


TOWN STREET SIGN

INSTALLATION

DATE OF ISSUE AUGUST 2015 REVISED:

DETAIL NUMBER:

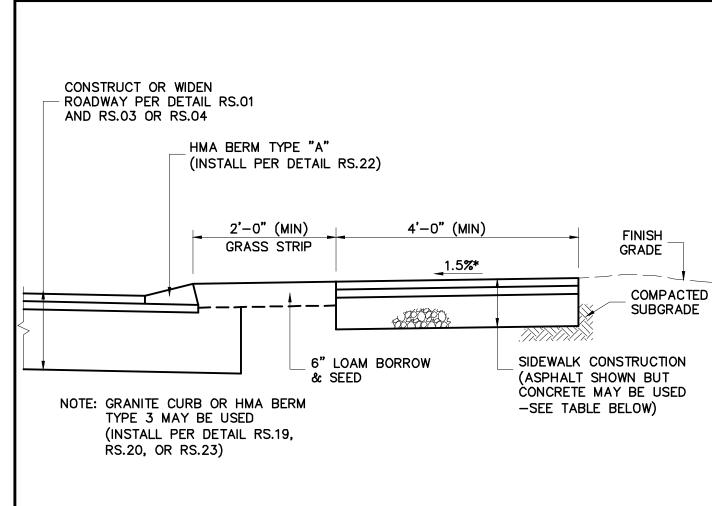MISC.06



ALSO REFERENCE CURRENT MassDOT CONSTRUCTION STANDARD DETAILS.

DEDHAM DPW

DESIGN & CONSTRUCTION STANDARDS

SIGN POST INSTALLATION

IN SIDEWALK

	CEMENT CONCRETE CONSTRUCTION	HOT MIX ASPHALT CONSTRUCTION
SURFACE:	4" CEMENT CONCRETE (4000 PSI, 3/4", 610)	2.5" HOT MIX ASPHALT (1.25" TOP COURSE MATERIAL OVER 1.25" BINDER COURSE MATERIAL)
BASECOURSE:	8" GRAVEL BORROW (TYPE "B")	8" GRAVEL BORROW (TYPE "B")

UNLESS OTHERWISE NOTED, CONSTRUCTION METHODS, MATERIAL REQUIREMENTS AND METHOD OF MEASUREMENT SHALL BE IN ACCORDANCE WITH THE LATEST EDITION OF THE MASSACHUSETTS DEPARTMENT OF TRANSPORTATION (MassDOT) STANDARD SPECIFICATIONS.

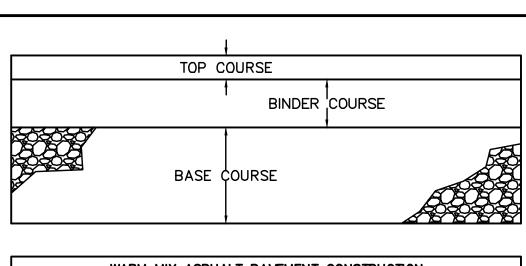
SIDEWALK WITH GRASS STRIP

ALSO REFERENCE CURRENT MassDOT CONSTRUCTION STANDARD DETAILS.



DEDHAM DPW DESIGN & CONSTRUCTION STANDARDS

DATE OF ISSUE CALE NTS AUGUST 2015 DETAIL NUMBER: RS.18



WARM MIX ASPHALT PAVEMENT CONSTRUCTION						
	ARTERIAL	COLLECTOR	LOCAL			
TOP COURSE THICKNESS (IN):	2	2	1-1/2			
BINDER COURSE THICKNESS (IN):	3	3	2			
BASE COURSE THICKNESS (IN):	12	12	12			

NOTES:

- 1) WARM MIX ASPHALT SHALL CONFORM TO THE LATEST VERSION OF THE MassDOT STANDARD SPECIFICATIONS.
- 2) WARM MIX ADDITIVES (WMAs) FOR FULL WIDTH ROAD CONSTRUCTION WMAs SHALL BE ADDED TO THE JOB—MIX FORMULA UNLESS OTHERWISE DIRECTED BY THE ENGINEER. NO OTHER CHANGES SHALL BE MADE IN THE JOB—MIX FORMULA WHEN ADDING WMAS UNLESS REQUIRED BY THE ENGINEER. ONLY WMAS LISTED ON THE NEAUPG QUALIFIED WMA TECHNOLOGIES LIST WILL BE ACCEPTED, AND SHALL BE LIMITED TO CHEMICAL ADDITIVES WHICH ARE CAPABLE OF REDUCING MIXTURE COMPACTION TEMPERATURES BY A MINIMUM OF 50°F. ADDITIVES POSSESSING ANTI-STRIPPING PROPERTIES ARE PREFERRED.
- 3) BASE COURSE MATERIAL SHALL BE GRAVEL BORROW M1.03.0 TYPE "B" FOR NEW ROADWAY CONSTRUCTION AND SHALL BE EITHER GRAVEL BORROW M1.03.0 TYPE "B" OR RECLAIMED PAVEMENT BORROW M1.09.0.
- 4) A TACK COAT CONSISTING OF ASPHALT EMULSION TYPE "RS-1" SHALL BE APPLIED OVER THE BINDER COURSE AT UNIFORM RATE OF 0.05 GALLONS PER SQUARE YARD IMMEDIATELY PRIOR TO INSTALLATION OF THE TOP COURSE.
- 5) RECLAMATION DEPTH SHALL BE A MINIMUM OF 12 INCHES. IF BOTTOM OF RECLAMATION IS ABOVE REQUIRED SUBGRADE, THE RECLAIMED MATERIAL SHALL BE REMOVED, THE EXISTING SUBGRADE SHALL BE EXCAVATED TO THE REQUIRED SUBGRADE ELEVATION AND RECLAIMED MATERIAL SHALL THEN BE PLACED TO THE REQUIRED GRADES. EXISTING SUBGRADE MAY REMAIN IN PLACE IF IT MEETS THE SPECIFICATION FOR GRAVEL BORROW
- 6) THE DIRECTOR OF ENGINEERING AND/OR THE DIRECTOR OF PUBLIC WORKS HAVE THE RIGHT TO REQUEST THAT A ROADWAY BE DESIGNED PER THE LATEST EDITION OF THE MassDOT PROJECT DEVELOPMENT AND DESIGN

UNLESS OTHERWISE NOTED, CONSTRUCTION METHODS, MATERIAL REQUIREMENTS AND METHOD OF MEASUREMENT SHALL BE IN ACCORDANCE WITH THE LATEST EDITION OF THE MASSACHUSETTS DEPARTMENT OF TRANSPORTATION (MassDOT) STANDARD SPECIFICATIONS.

ALSO REFERENCE CURRENT MassDOT CONSTRUCTION STANDARD DETAILS.

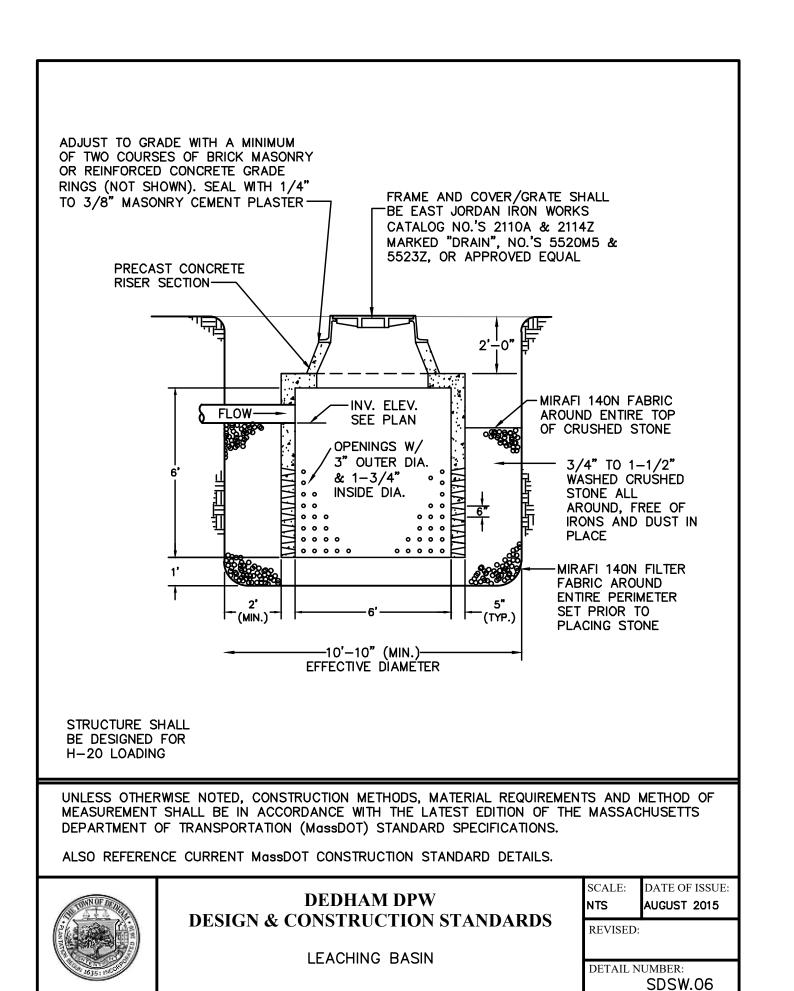


SCALE: **DEDHAM DPW DESIGN & CONSTRUCTION STANDARDS**

> TYPICAL ROADWAY SECTION FOR VARIOUS ROAD CLASSIFICATIONS

AUGUST 2015 REVISED: DETAIL NUMBER: RS.01

DATE OF ISSUE



Dewberry

99 SUMMER STREET SUITE 700

BOSTON, MASSACHUSETTS 02110 (617) 695-3400 (617) 695-3310

TOWN OF DEDHAM **MASSACHUSETTS**

PROJECT TITLE

GREENLODGE STREET CORRIDOR **IMPROVEMENTS**

SEAL

0 8/2022 FINAL Description REVISIONS

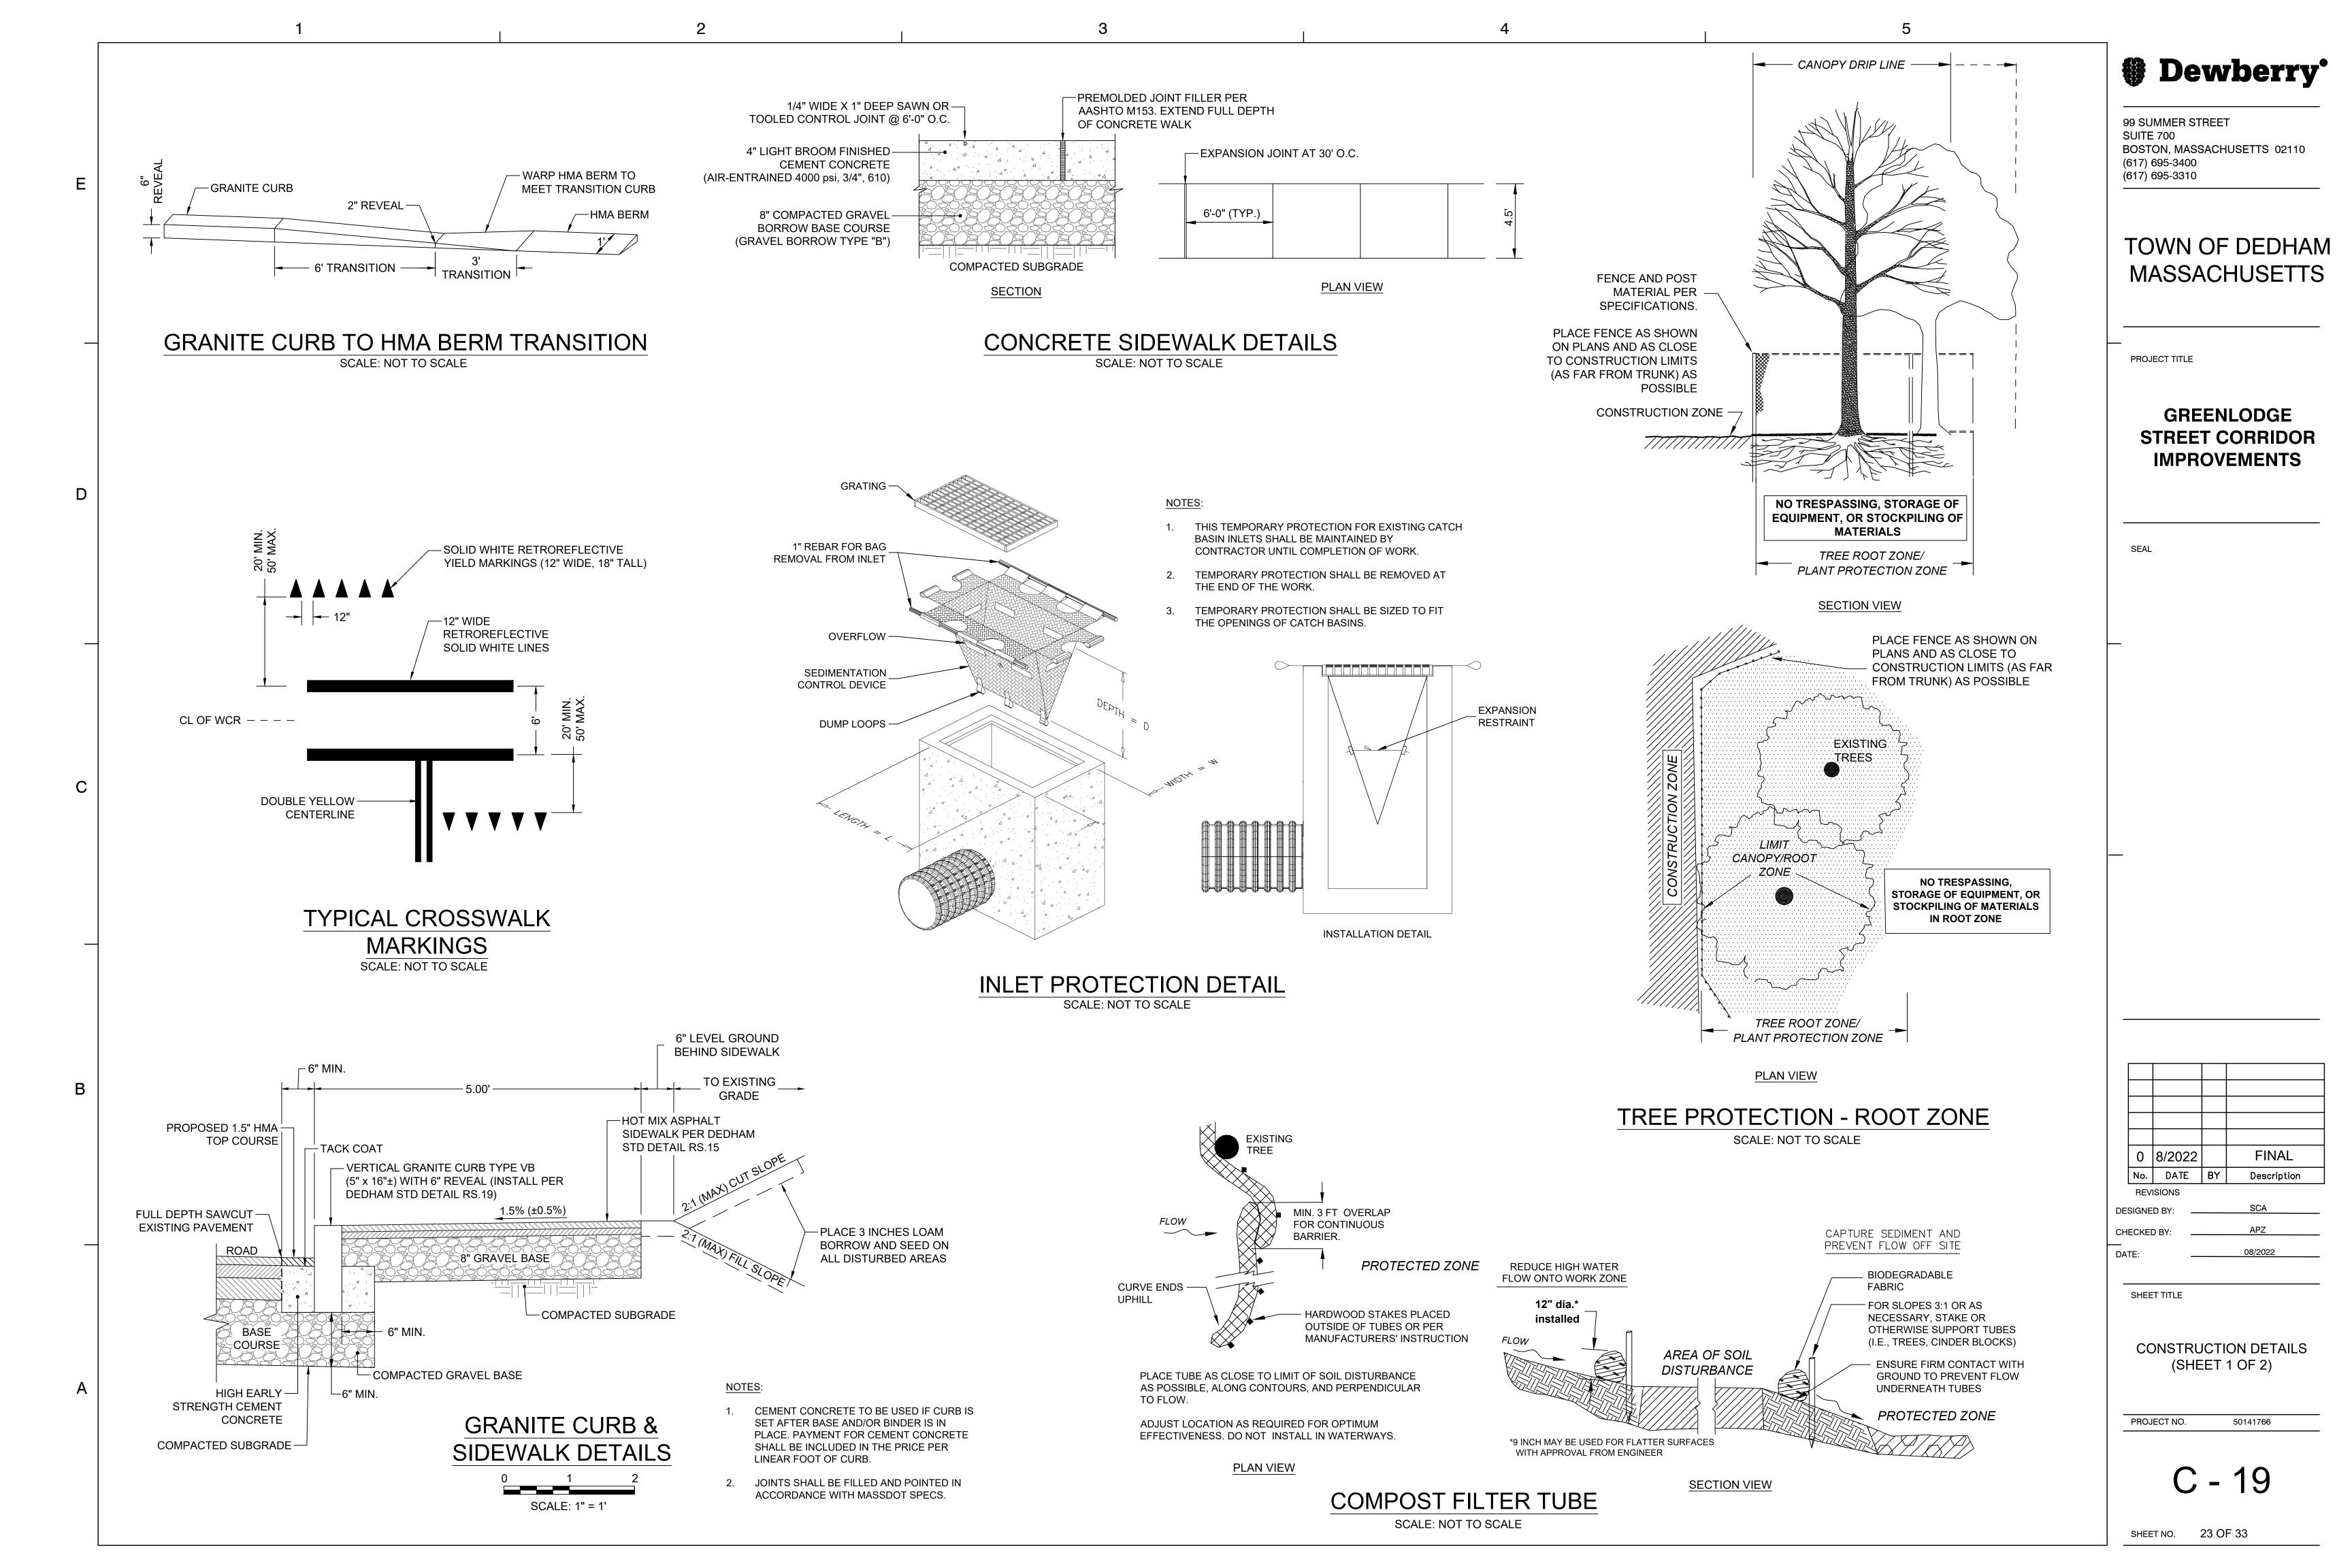
DESIGNED BY: CHECKED BY: DATE:

SHEET TITLE

DEDHAM STANDARD DETAILS (SHEET 4 OF 4)

PROJECT NO. 50141766

SHEET NO. 22 OF 33



WHEELCHAIR RAMP NOTES:

- 1. CROSS SLOPE OF CURB RAMPS SHALL BE 1.5% ± 0.5%.
- 2. RAMP TRANSITIONS BETWEEN WALKS, LANDINGS, GUTTERS, OR STREETS SHALL BE FLUSH AND FREE OF ABRUPT VERTICAL CHANGES (1/4" MAX.).
- DETECTABLE WARNING PANELS ARE REQUIRED ON ALL PROPOSED WHEELCHAIR RAMPS. SEE DETAIL RS.13.
- 4. ROADWAY GUTTER SLOPE MEASURED MOVING UPSTATION.
- 5. MINIMUM OF 3' CLEAR SPACE SHALL BE MAINTAINED AT ANY PERMANENT OBSTACLE (I.E. HYDRANTS, UTILITY POLES, LIGHTS, TREE PITS, SIGNS, ETC.) ALONG THE ACCESSIBLE ROUTE.
- 6. RAMP, CURB, AND ADJACENT PAVEMENTS SHALL BE GRADED SO AS TO PREVENT PONDING.
- 7. REFER TO GRADING PLANS FOR CURB RADII AT WHEELCHAIR RAMPS.


PEDESTRIAN CURB RAMP DETAILS									
PEDESTRIAN CURB RAMP	RAM	1P REFERENCE		WIDTH OF SIDEWALK	WIDTH OF	TRANSITION RAMP LENGTH (FT)		GUTTER	
#	BASELINE	STATION	OFFSET (FT)	(FT)	RAMP (FT)	HIGH SIDE	LOW SIDE	SLOPE (%)	NOTES
W1	Greenlodge St	10+92.52	24.63 RT	5	6.8	9'-0"	6'-6"	1.3	
W2	Greenlodge St	11+30.15	22.91 RT	6.2	5	3'-6"	6'-6"	0.5	USE 3" CURB REVEAL BETWEEN W2 & W4
W3	Greenlodge St	11+44.48	12.68 LT	3.8	5	0	0	1.8	At UP/Driveway
W4	Greenlodge St	11+44.48	14.51 RT	5	5	11'-0"	3'-6"	2.3	USE 3" CURB REVEAL BETWEEN W2 & W4
W5	Fox Meadow Ln	71+30.78	19.29 LT	8	7.5	7'-8"	6'-6"	-0.2	
W6	Fox Meadow Ln	71+30.15	19.41 RT	5	6.5	15'-0"	6'-6"	-5	
W7	Greenlodge St	19+55.13	18.50 RT	5	6	14'-0"	6'-6"	-3.6	
W8	Greenlodge St	20+05.53	18.50 RT	5	6.3	15'-0"	6'-6"	7.2	
W9	Greenlodge St	22+40.35	19.00 RT	5	6.3	14'-0"	6'-6"	4	
W10	Greenlodge St	22+91.20	19.00 RT	5	6.3	3'-6"	6'-6"	6.2	USE 3" CURB REVEAL BETWEEN W10 & W12
W11	Greenlodge St	23+09.49	16.16 LT	8.25	6	15'-0"	0	5.3	
W12	Greenlodge St	23+09.48	13.5 RT	5	6	15'-0"	3'-6"	5.7	USE 3" CURB REVEAL BETWEEN W10 & W12
W13	Greenlodge St	29+49.27	10.0 LT	7.6	5	9'-0"	6'-6"	1.5	
W14	Greenlodge St	29+49.27	14.63 RT	5	5	0	6'-6"	2	USE 3" CURB REVEAL BETWEEN W14 & W15
W15	Colwell Dr	80+19.02	18.95 RT	5	6.3	9'-0"	0	1.5	USE 3" CURB REVEAL BETWEEN W14 & W15
W16	Colwell Dr	80+19.02	20.71 LT	5	6.3	9'-0"	6'-6"	1.6	
W17	Greenlodge St	32+82.84	19.37 RT	5	6	14'-0"	6'-6"	3.1	
W18	Greenlodge St	33+35.26	19.00 RT	5	5	9'-0"	6'-6"	1.5	
W19	Greenlodge St	35+48.03	16.6 LT	6.4	5	6'-6"	6'-6"	1.5	
W20	Greenlodge St	35+48.03	14.0 RT	5	5	9'-0"	6'-6"	1.5	
W21	Greenlodge St	35+67.29	25.64 RT	5	5	14'-0"	6'-6"	3.2	
W22	Greenlodge St	35+98.40	24.05 RT	5	5	14'-0"	6'-6"	-4	
W23	Greenlodge St	40+06.57	18.26 LT	5	6.3	14'-0"	6'-6"	4	
W24	Greenlodge St	40+47.78	19.20 LT	8.3	8	14'-0"	6'-6"	3.1	

	RAMP REFER	FNCF POINT			
DRIVEWAY ID	STATION	OFFSET (FT)	GUTTER SLOPE (%)	HSL (FT)	NOTES
D1	12+46	12 RT	1.48	9'-0"	
D2	14+02	12 RT	1.9	9'-0"	
D3	15+54	12 RT	2.9	11'-0"	
D4	17+18	12 RT	0.52	7'-8"	
D5	17+56	12 RT	0.81	7'-8"	
D6	18+16	12 RT	1.73	N/A	LOW POINT
D7	18+49	12 RT	2.31	11'-0"	LOW SIDE CONTINUOUS TO DE
D8	20+63	12 RT	8.19	15'-0"	
D9	23+81	14 RT	5.62	15'-0"	
D10	25+03	14 RT	2.31	11'-0"	
D11	26+06	14 RT	2.31	N/A	
D12	26+39	14 RT	2.31	11'-0"	LOW SIDE CONTINUOUS TO D1
D13	27+26	14 RT	0.96	7'-8"	
D14	28+48	14 RT	0.46	3'-0"	3' TRANSITIONS BOTH SIDES
D15	29+04	14 RT	2.65	3'-0"	3' TRANSITIONS BOTH SIDES
D16	31+38	14 RT	0.98	7'-8"	
D17	34+30	14 RT	-0.17	7'-8"	
D18	35+04	14 RT	0.88	7'-8"	
D19	37+69	12 RT	3.1	N/A	
D20	38+00	12 RT	3.1	14'-0"	LOW SIDE CONTINUOUS TO D1
D21	39+53	12 RT	8.27	15'-0"	
D22	40+08	12 RT	7.28	15'-0"	
D23	41+28	12 RT	3.48	14'-0"	
D24	42+03	12 RT	-0.37	N/A	
D25	42+37	12 RT	-0.2	7'-8"	LOW SIDE CONTINUOUS TO D2
D26	43+03	12 RT	-1.14	9'-0"	
D27	43+57	12 RT	-1.14	9'-0"	
D28	44+28	12 RT	-1.01	9'-0"	
D29	45+00	12 RT	-1.08	9'-0"	
D30	45+51	12 RT	0.51	7'-8"	LOW POINT
D31	45+84	12 RT	0.51	7'-8"	
D32	46+63	12 RT	0.51	7'-8"	
D33	47+44	12 RT	-0.21	7'-8"	
D34	15+38	14.8 LT	1.9	9'-0"	
D35	38+32	12.4 LT	3.34	14'-0"	
D36	38+66	12.7 LT	5.4	15'-0"	


DRIVEWAY ID	STATION	OFFSET (FT)	GUTTER SLOPE (%)	HSL (FT)	NOTES
D1	12+46	12 RT	1.48	9'-0"	
D2	14+02	12 RT	1.9	9'-0"	
D3	15+54	12 RT	2.9	11'-0"	
D4	17+18	12 RT	0.52	7'-8"	
D5	17+56	12 RT	0.81	7'-8"	
D6	18+16	12 RT	1.73	N/A	LOW POINT
D7	18+49	12 RT	2.31	11'-0"	LOW SIDE CONTINUOUS TO D6
D8	20+63	12 RT	8.19	15'-0"	
D9	23+81	14 RT	5.62	15'-0"	
D10	25+03	14 RT	2.31	11'-0"	
D11	26+06	14 RT	2.31	N/A	
D12	26+39	14 RT	2.31	11'-0"	LOW SIDE CONTINUOUS TO D11
D13	27+26	14 RT	0.96	7'-8"	
D14	28+48	14 RT	0.46	3'-0"	3' TRANSITIONS BOTH SIDES
D15	29+04	14 RT	2.65	3'-0"	3' TRANSITIONS BOTH SIDES
D16	31+38	14 RT	0.98	7'-8"	
D17	34+30	14 RT	-0.17	7'-8"	
D18	35+04	14 RT	0.88	7'-8"	
D19	37+69	12 RT	3.1	N/A	
D20	38+00	12 RT	3.1	14'-0"	LOW SIDE CONTINUOUS TO D19
D21	39+53	12 RT	8.27	15'-0"	
D22	40+08	12 RT	7.28	15'-0"	
D23	41+28	12 RT	3.48	14'-0"	
D24	42+03	12 RT	-0.37	N/A	
D25	42+37	12 RT	-0.2	7'-8"	LOW SIDE CONTINUOUS TO D24
D26	43+03	12 RT	-1.14	9'-0"	
D27	43+57	12 RT	-1.14	9'-0"	
D28	44+28	12 RT	-1.01	9'-0"	
D29	45+00	12 RT	-1.08	9'-0"	
D30	45+51	12 RT	0.51	7'-8"	LOW POINT
D31	45+84	12 RT	0.51	7'-8"	
D32	46+63	12 RT	0.51	7'-8"	
D33	47+44	12 RT	-0.21	7'-8"	
D34	15+38	14.8 LT	1.9	9'-0"	
D35	38+32	12.4 LT	3.34	14'-0"	
D36	38+66	12.7 LT	5.4	15'-0"	

SIGNS INSTALLED PER MUTCD RETROREFLECTIVE MATERIAL WITH YELLOW BACKGROUND ON SIGN POST: • 2" WIDE (MINIMUM) • INSTALL CONTINUOUSLY FROM GROUND TO BASE OF LOWEST SIGN • MATCH SIGN BACKGROUND COLOR BACK OF SIDEWALK TRAVELED WAY

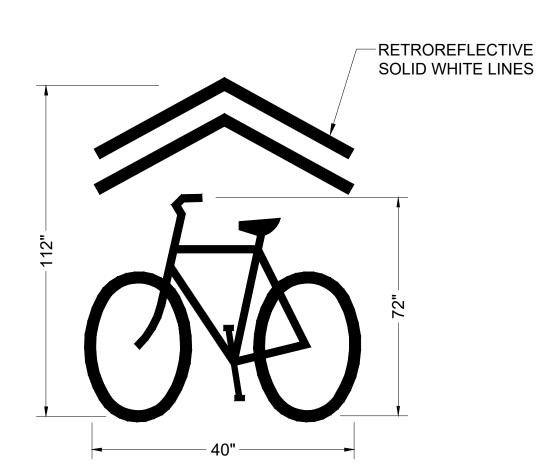CROSSWALK SIGN INSTALLATION SCALE: NOT TO SCALE



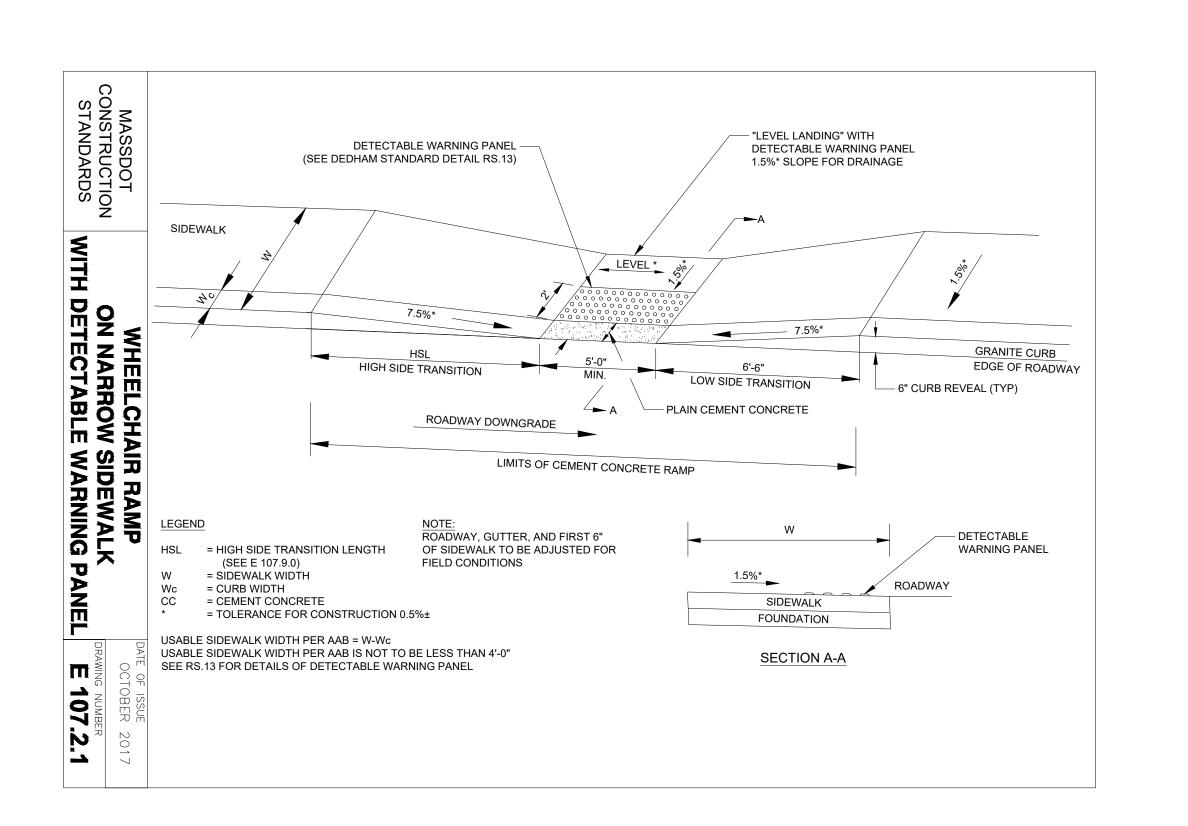SHARED LANE MARKING **INSTALLATION** SCALE: NOT TO SCALE



Dewberry*

99 SUMMER STREET SUITE 700

BOSTON, MASSACHUSETTS 02110 (617) 695-3400 (617) 695-3310

TOWN OF DEDHAM MASSACHUSETTS

PROJECT TITLE

GREENLODGE STREET CORRIDOR **IMPROVEMENTS**

SEAL

FINAL 0 8/2022 No. DATE BY Description REVISIONS DESIGNED BY:

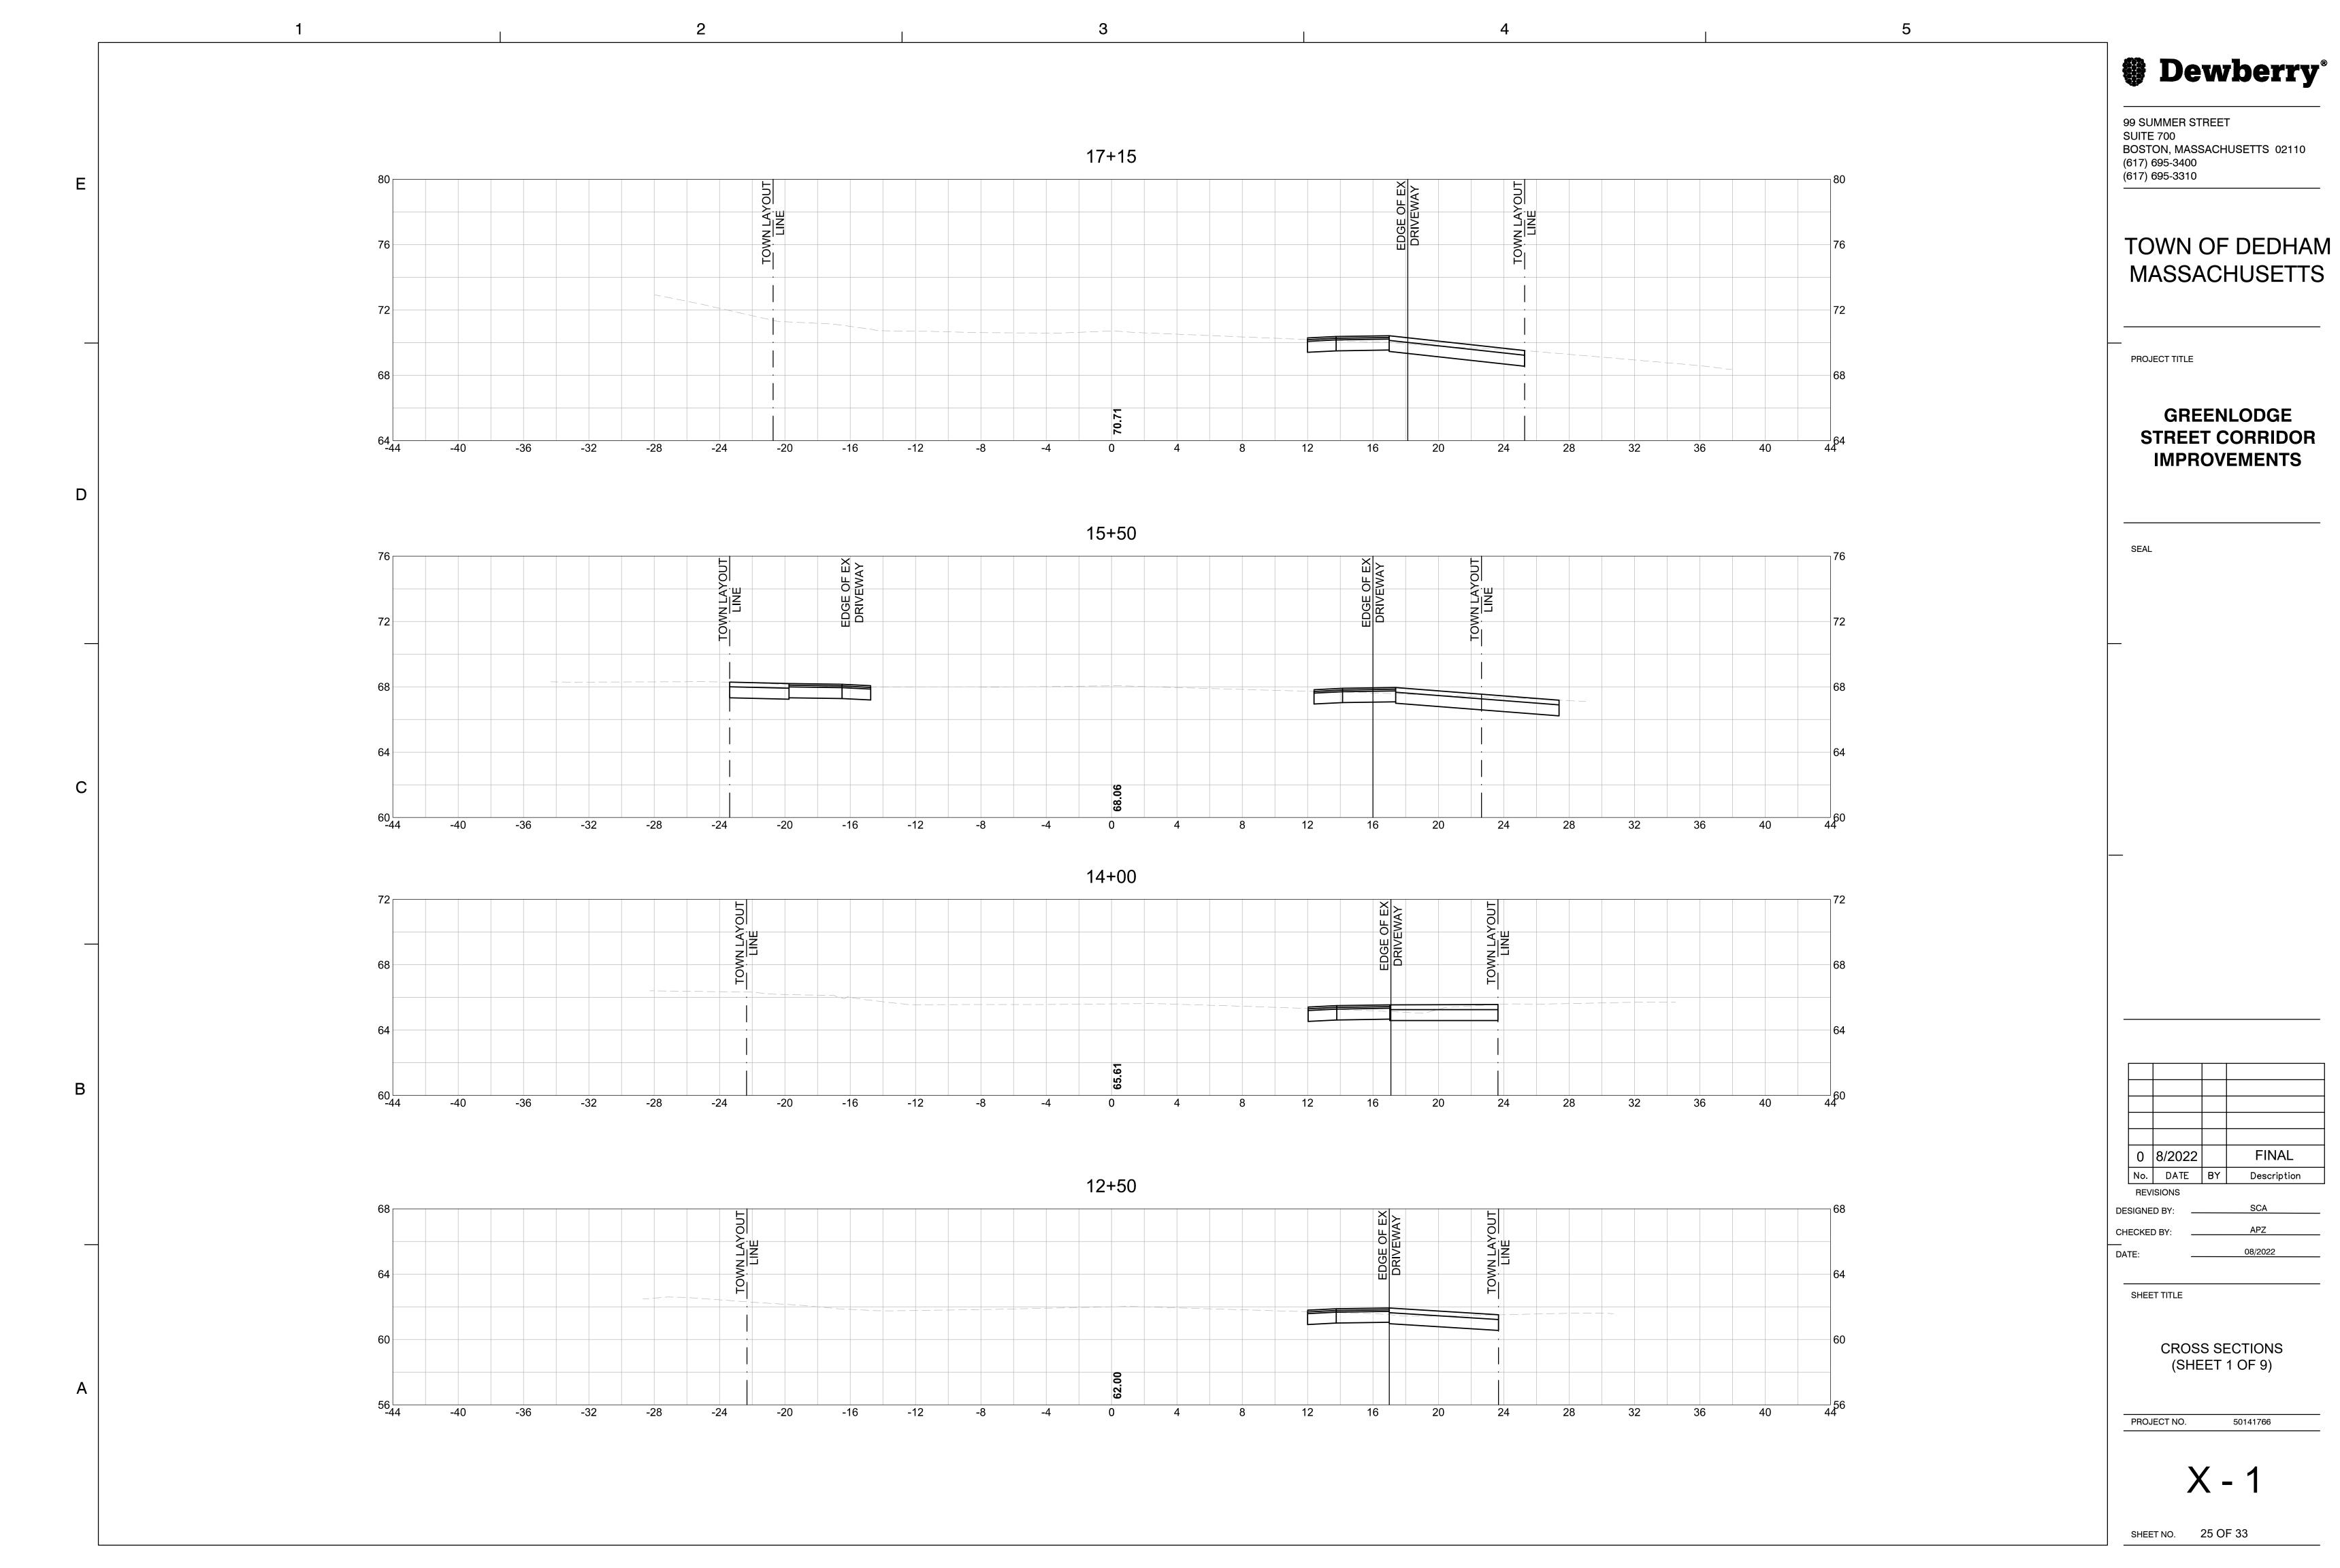
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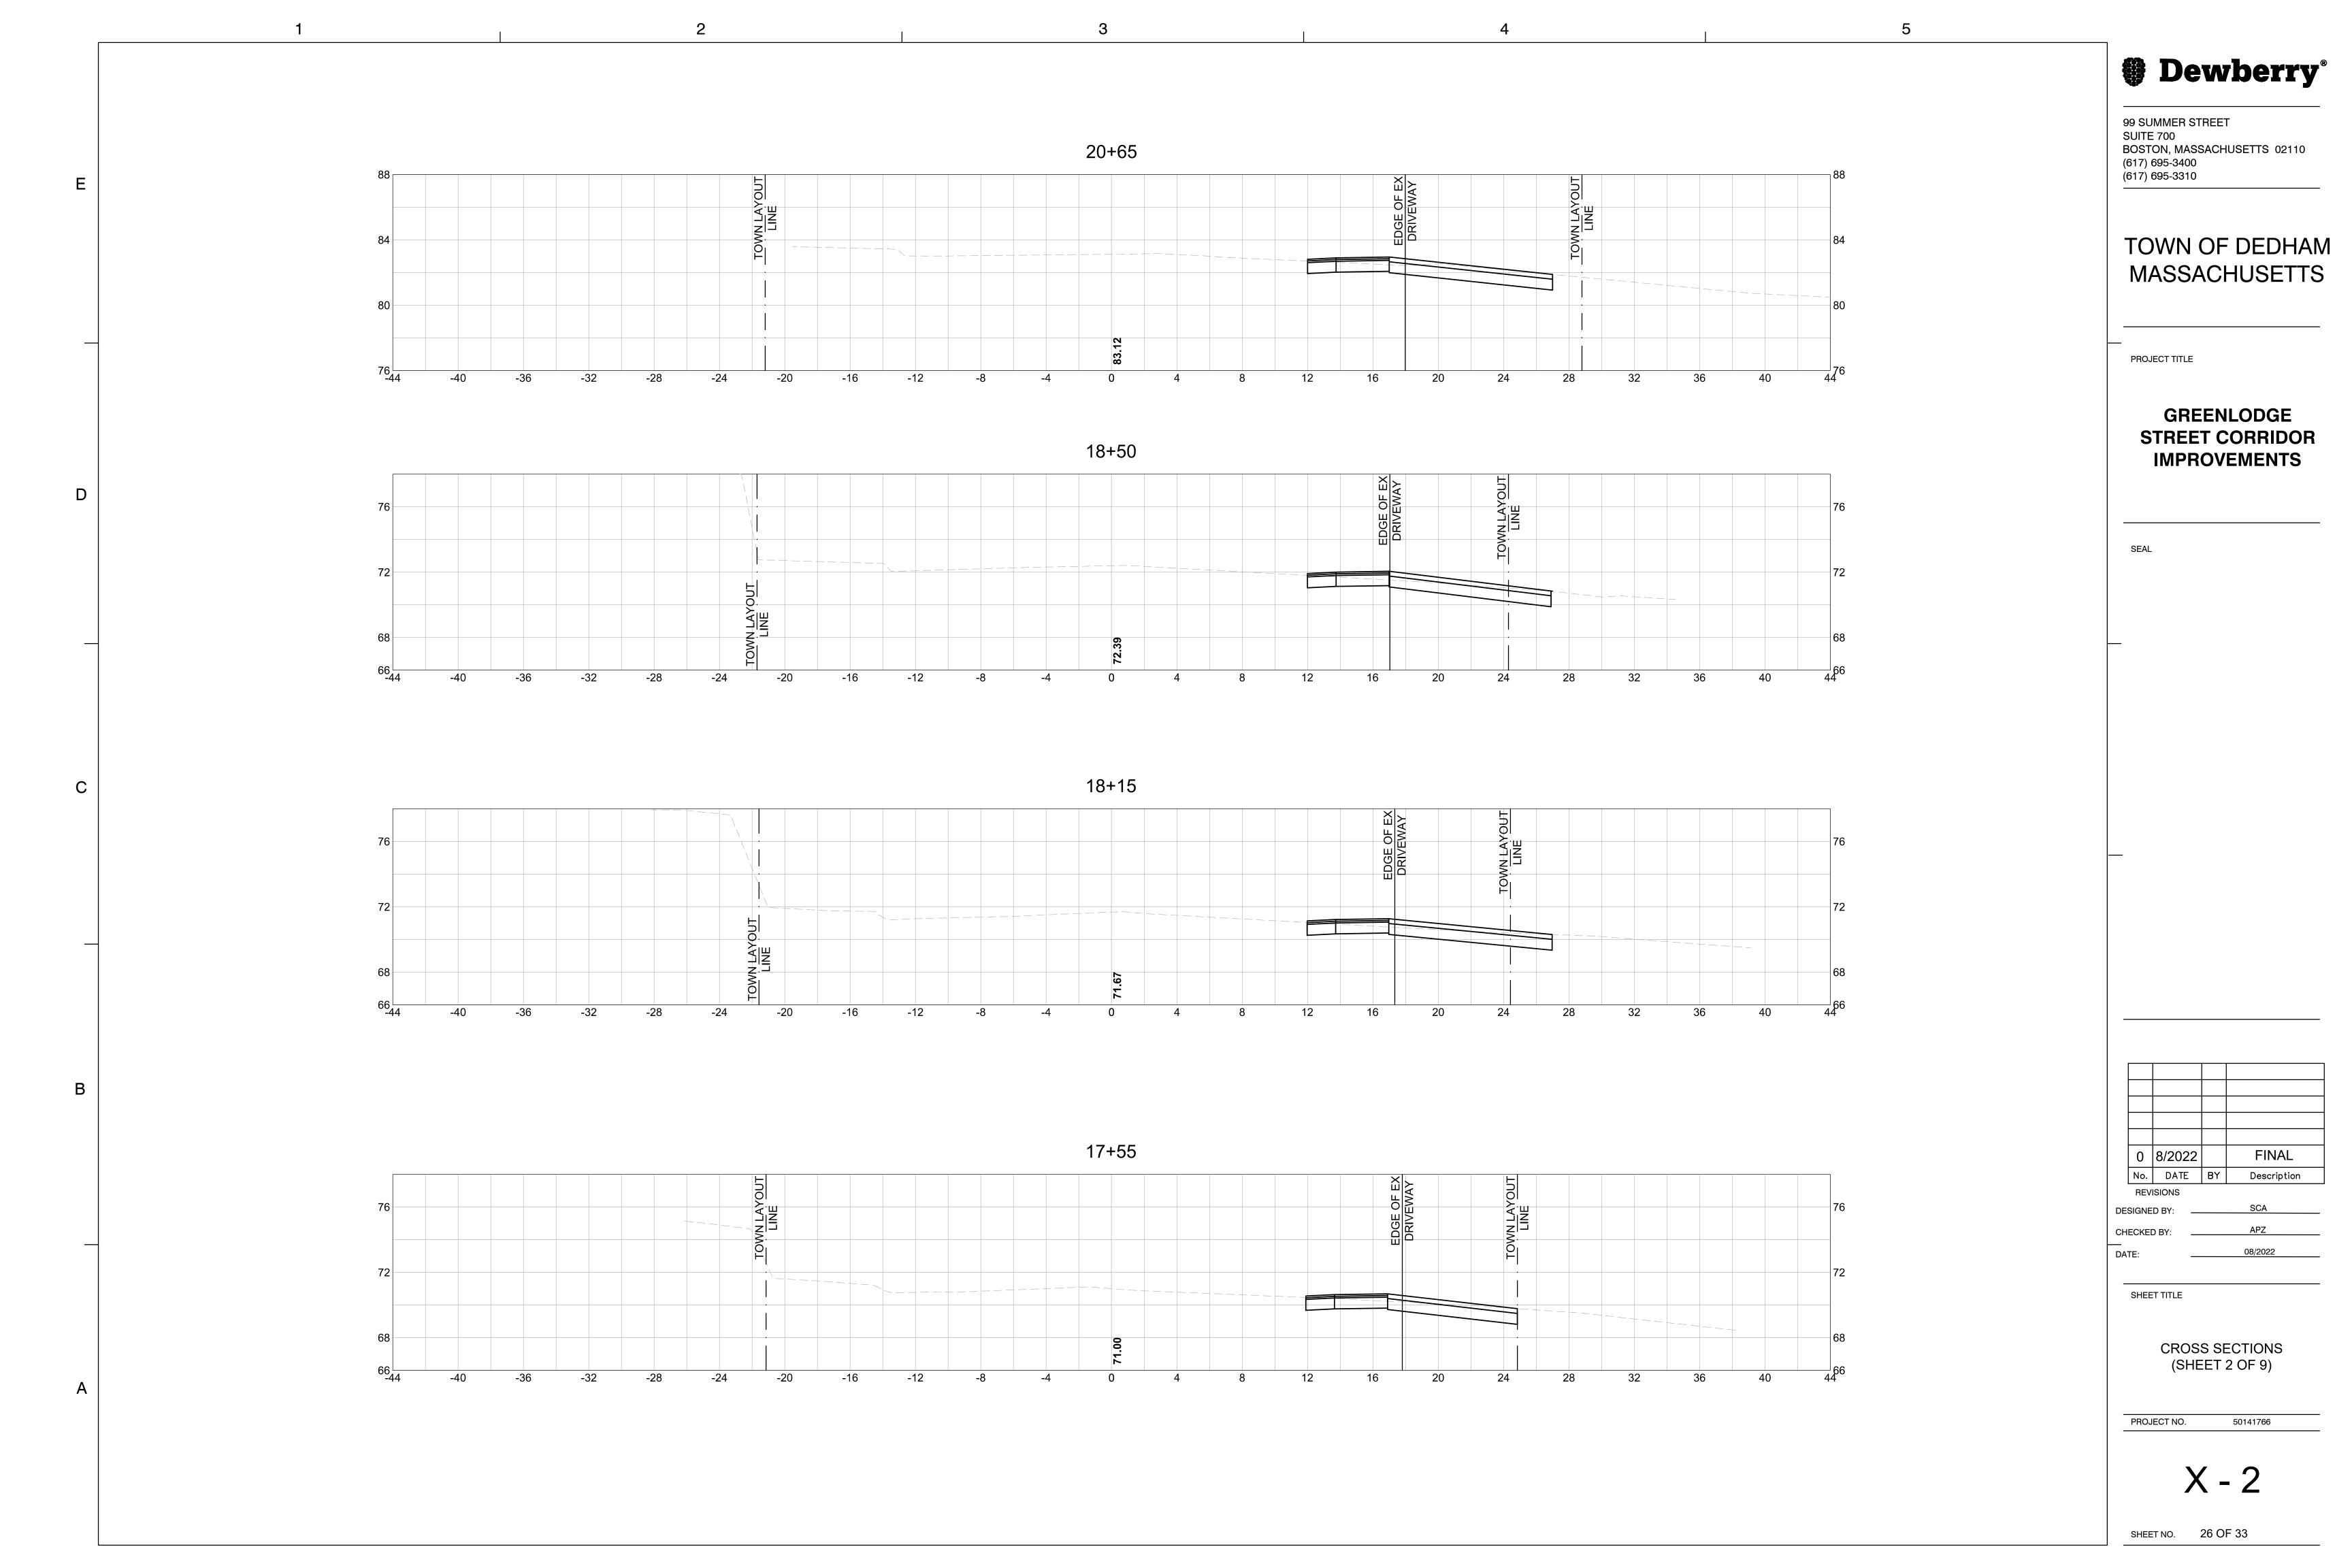
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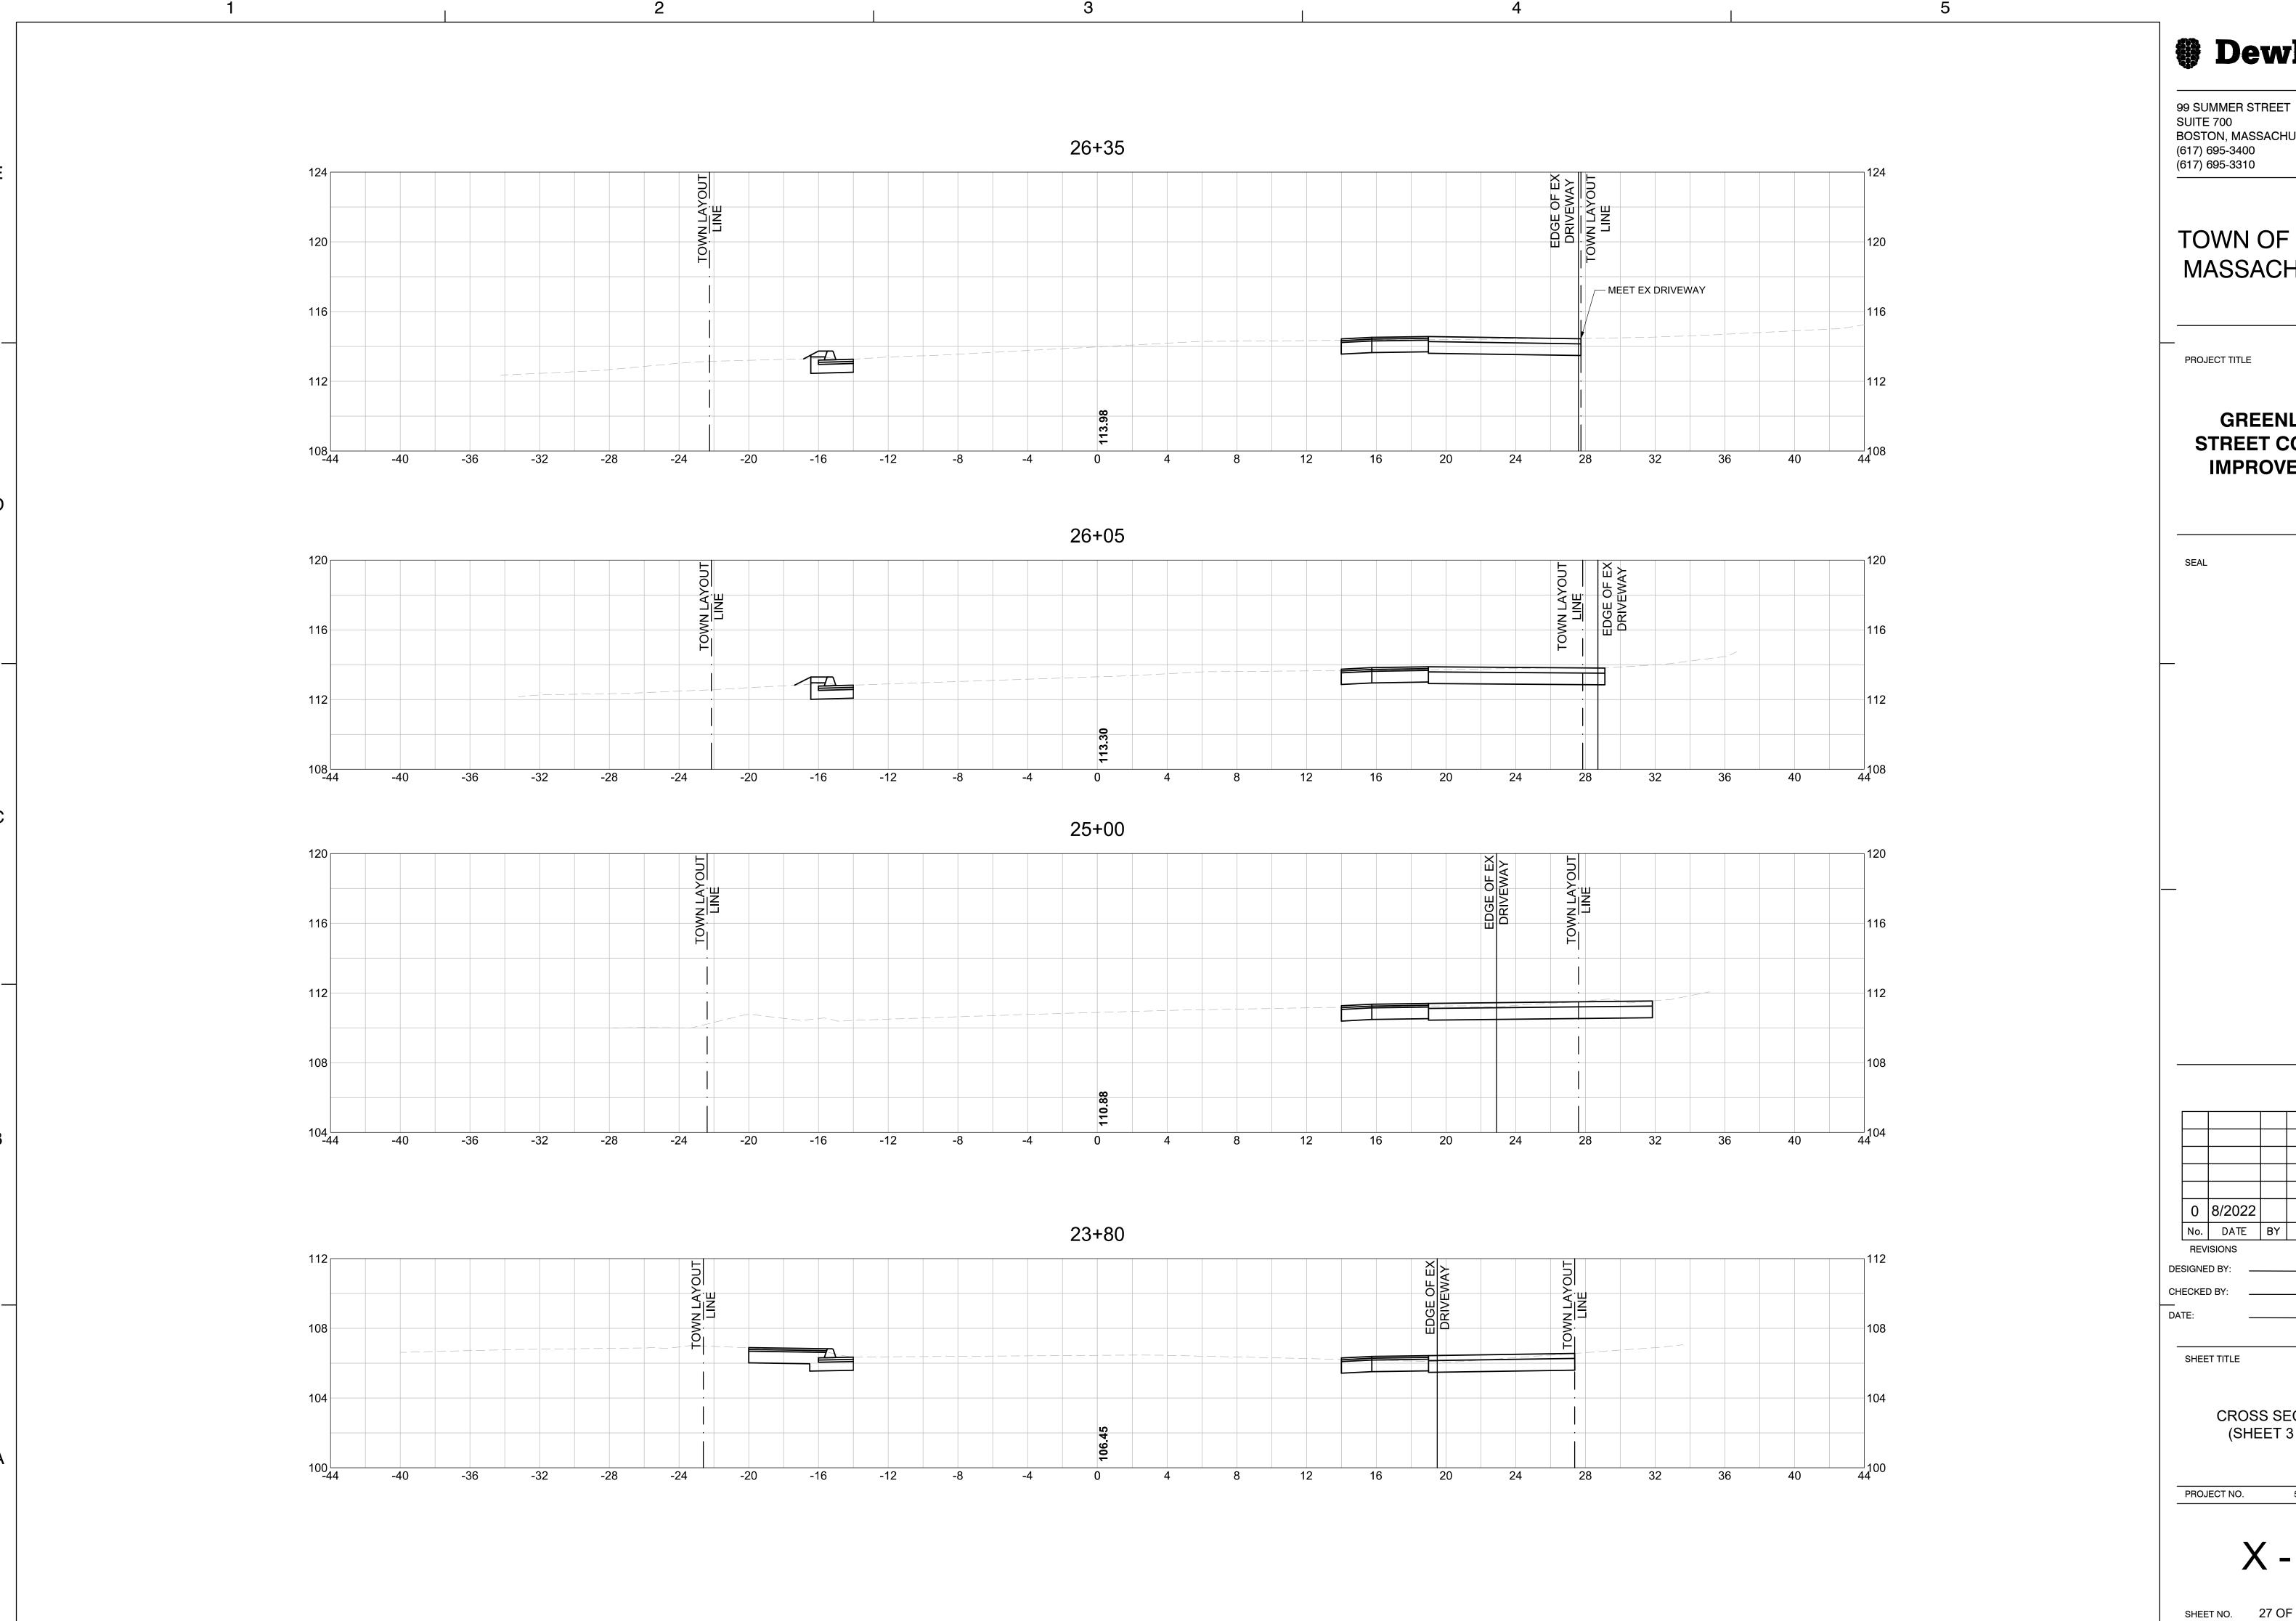
CONSTRUCTION DETAILS (SHEET 2 OF 2)

PROJECT NO. 50141766

SHEET NO. 24 OF 33







Dewberry*

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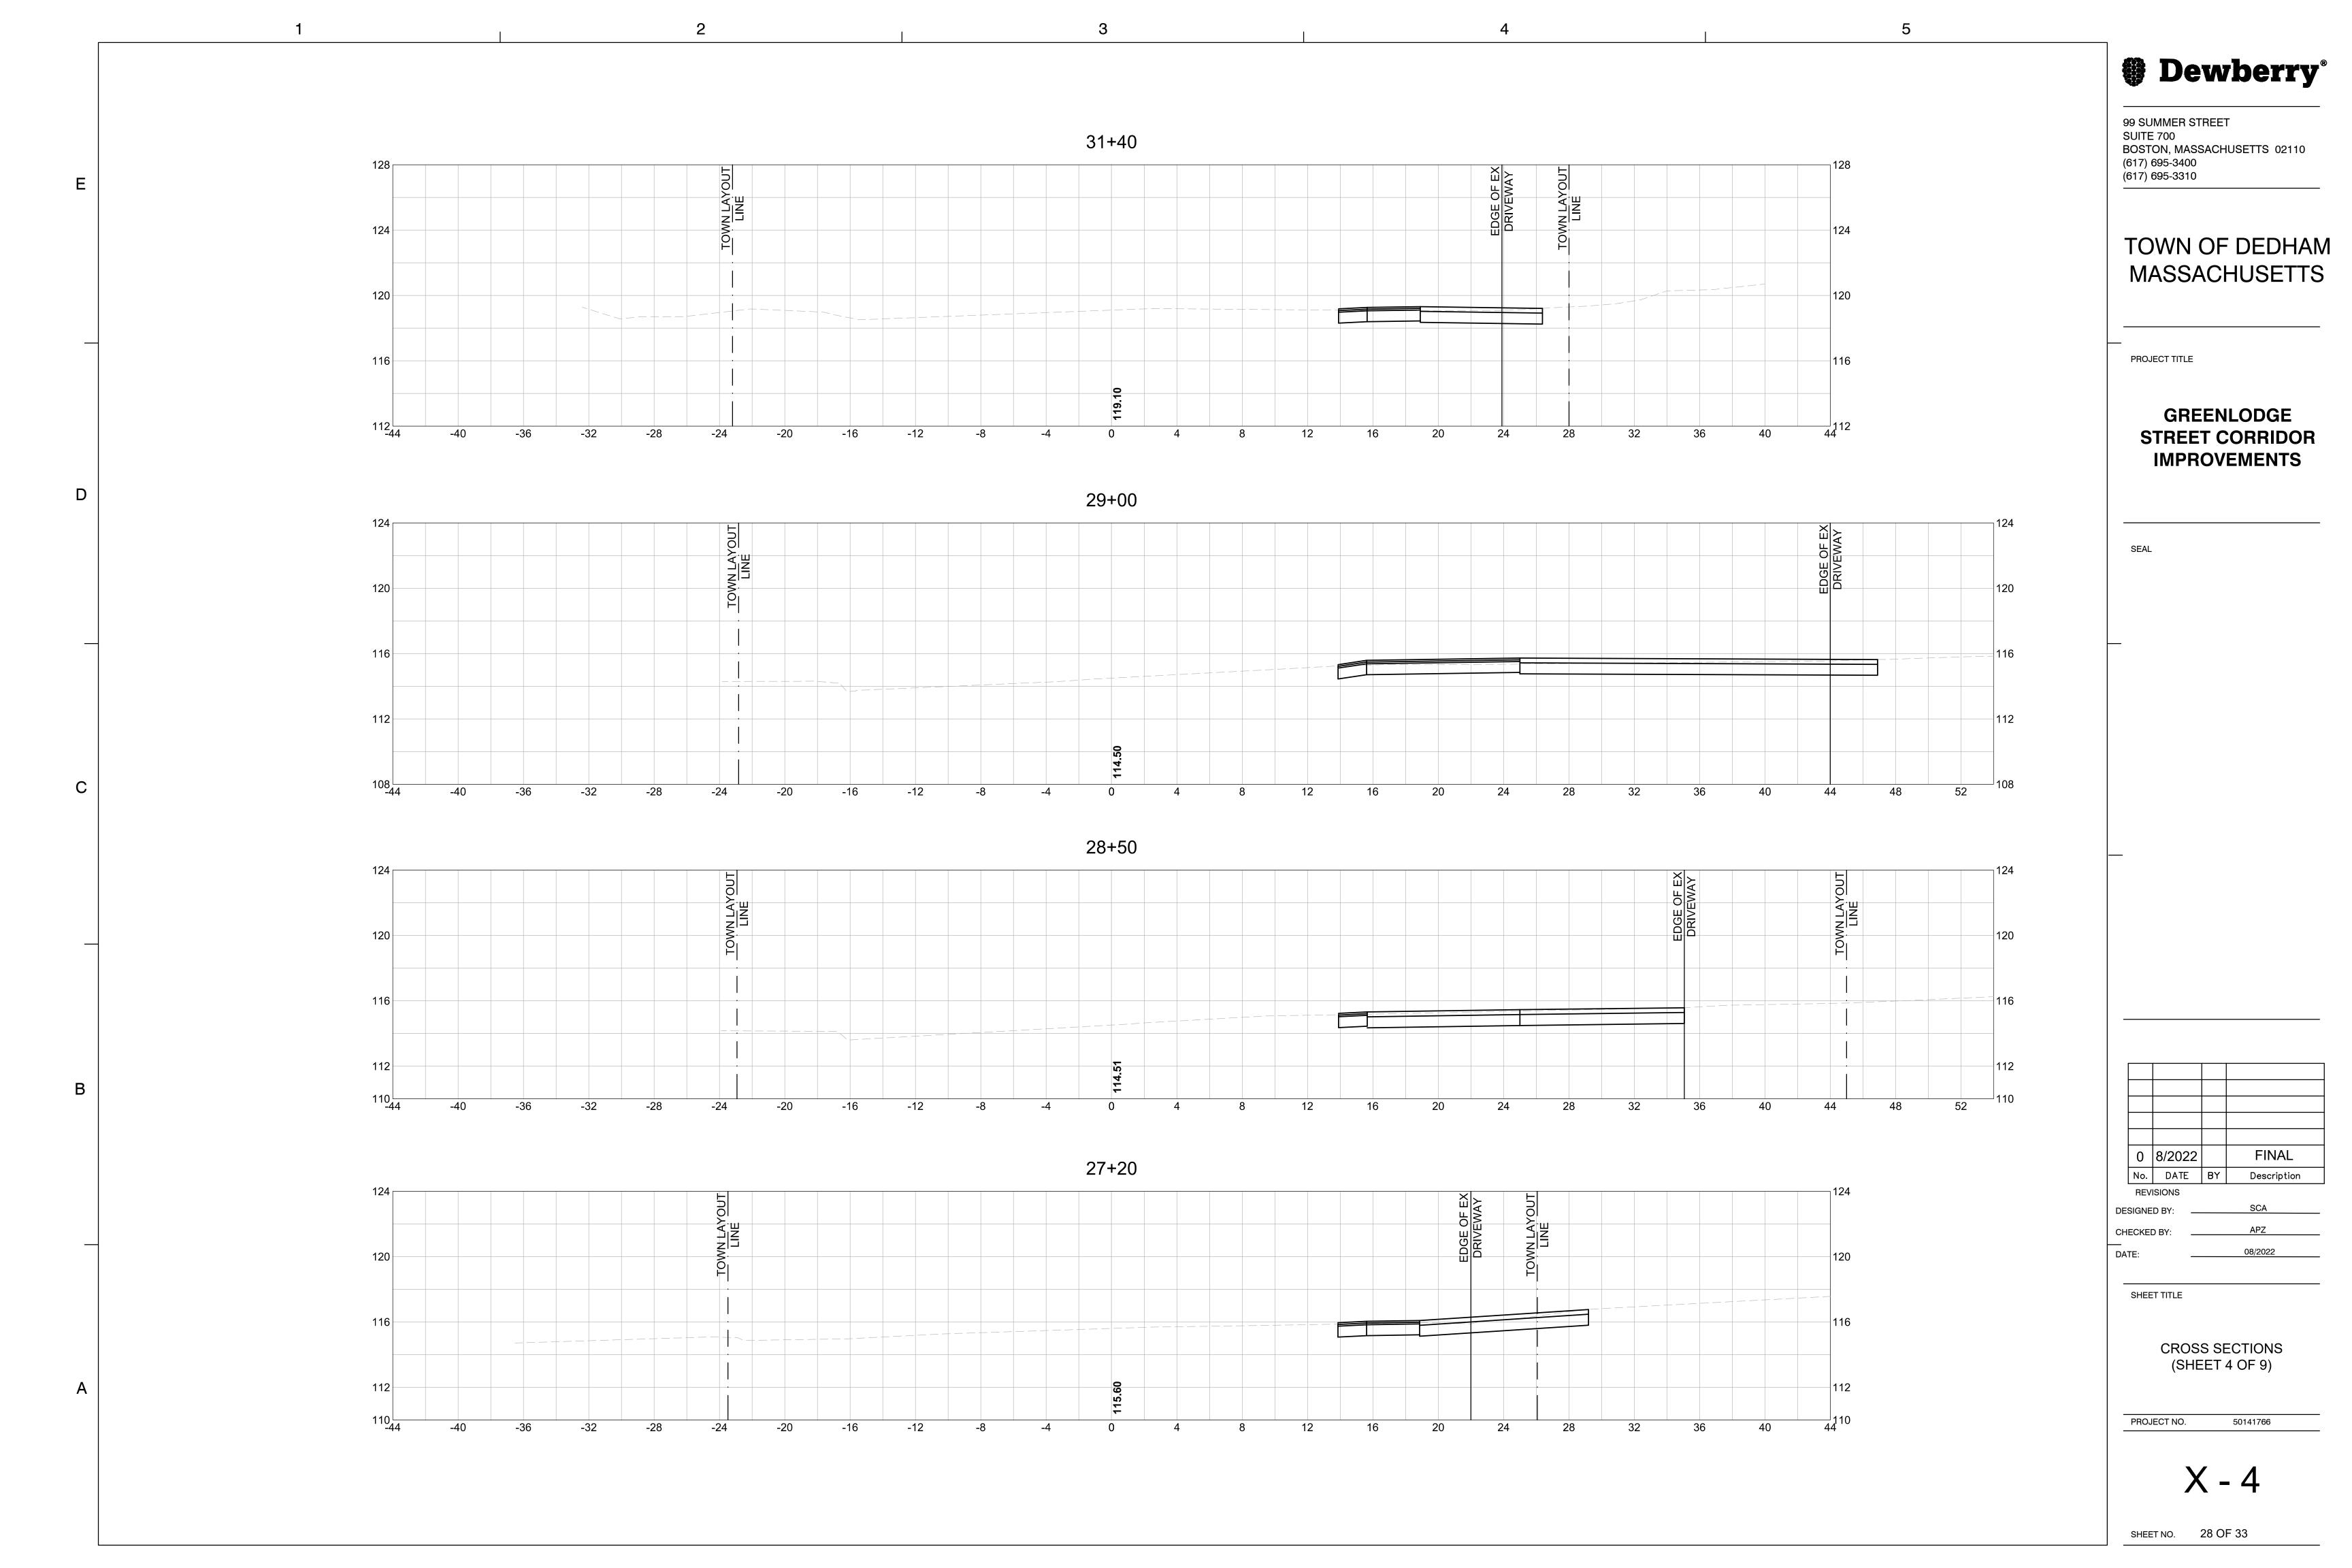
GREENLODGE STREET CORRIDOR **IMPROVEMENTS**

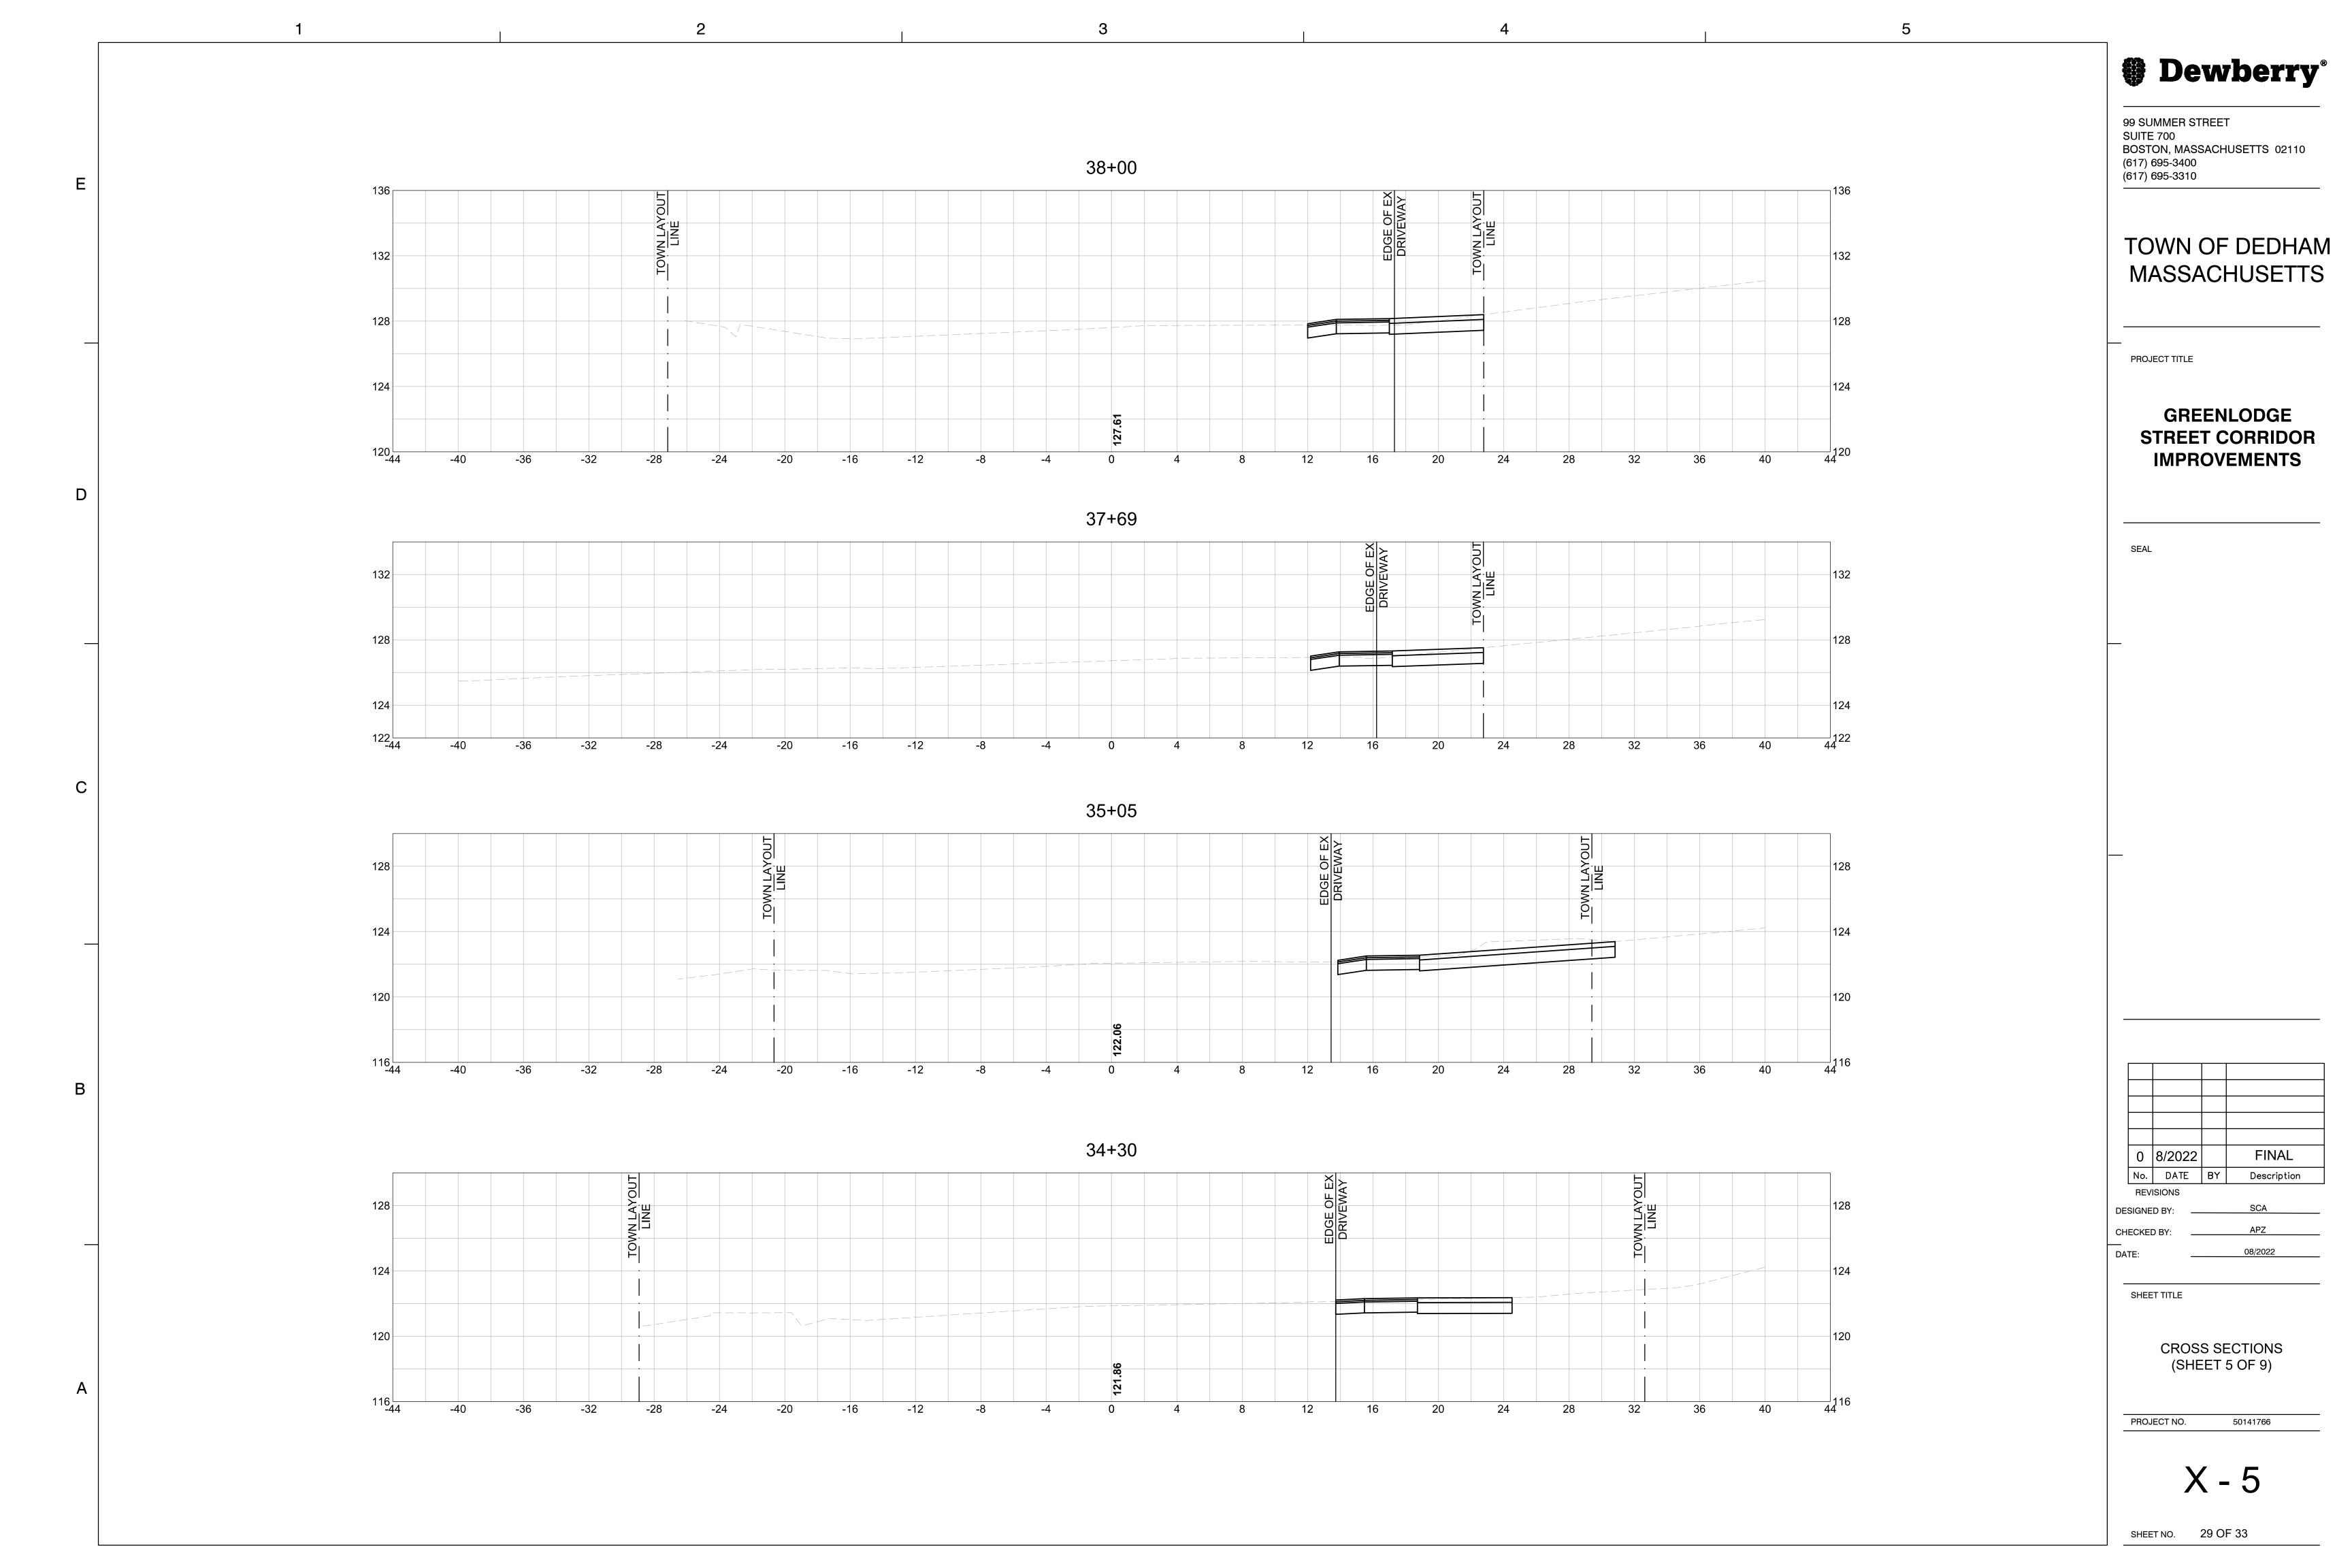
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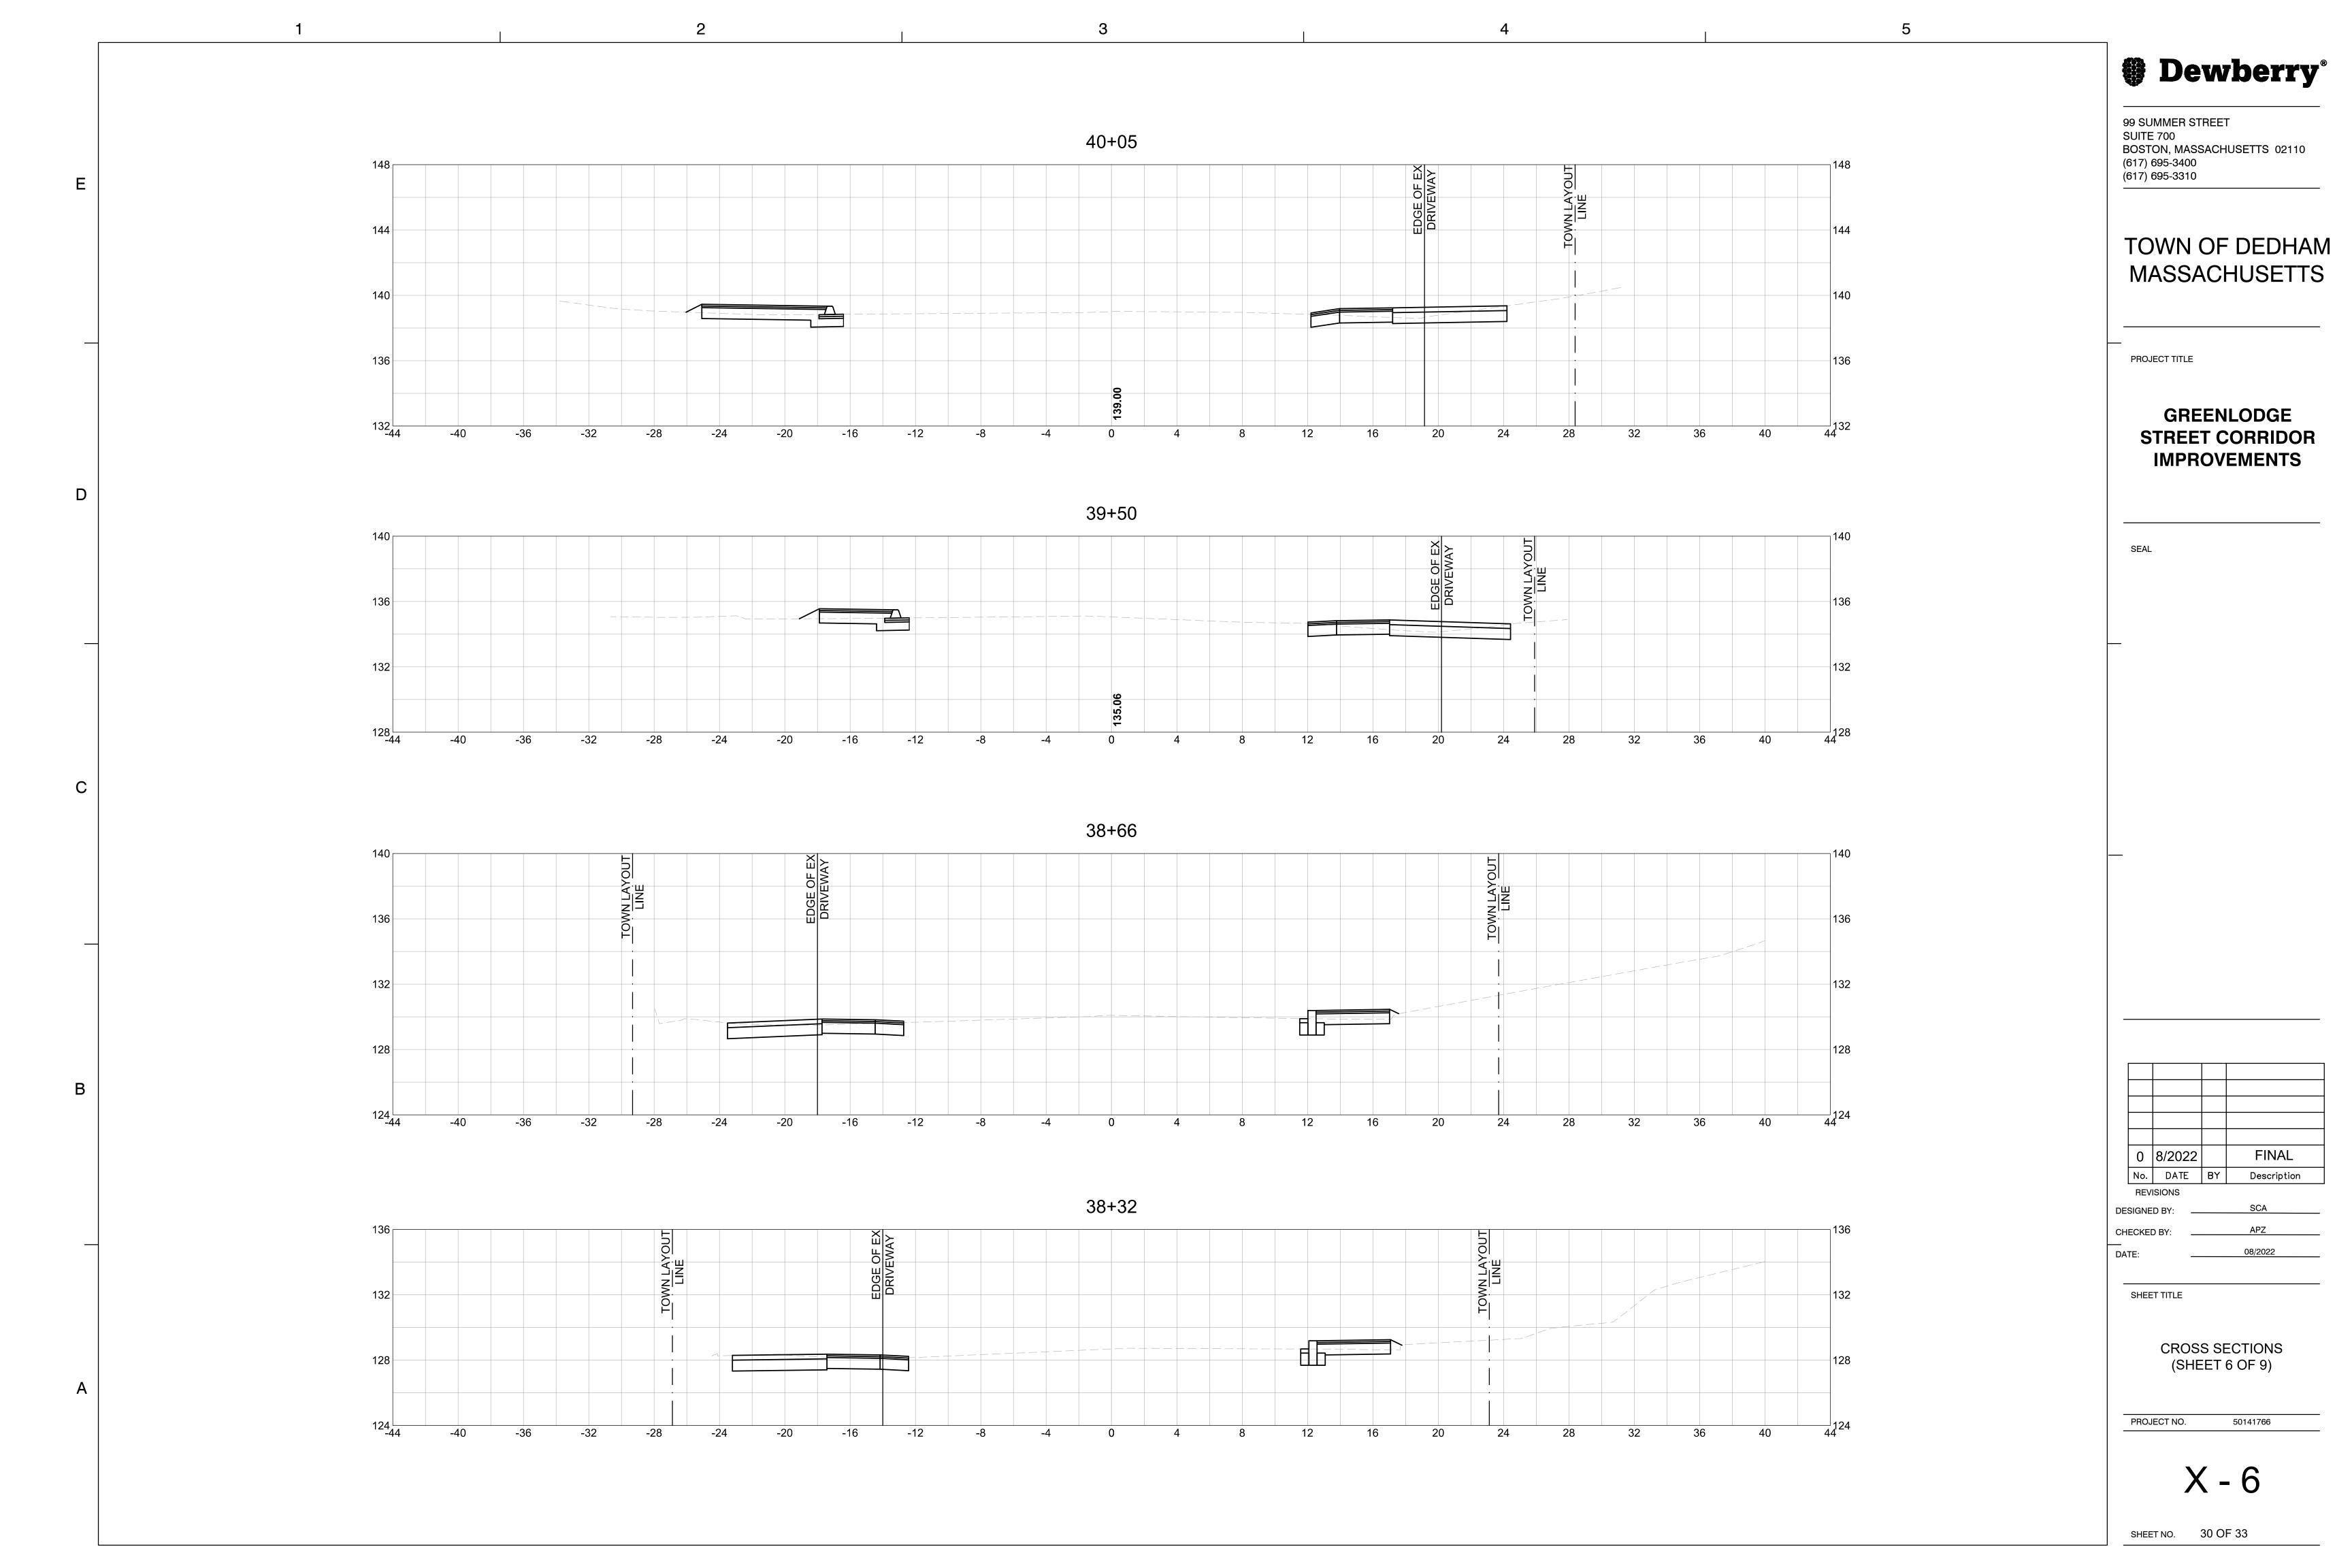
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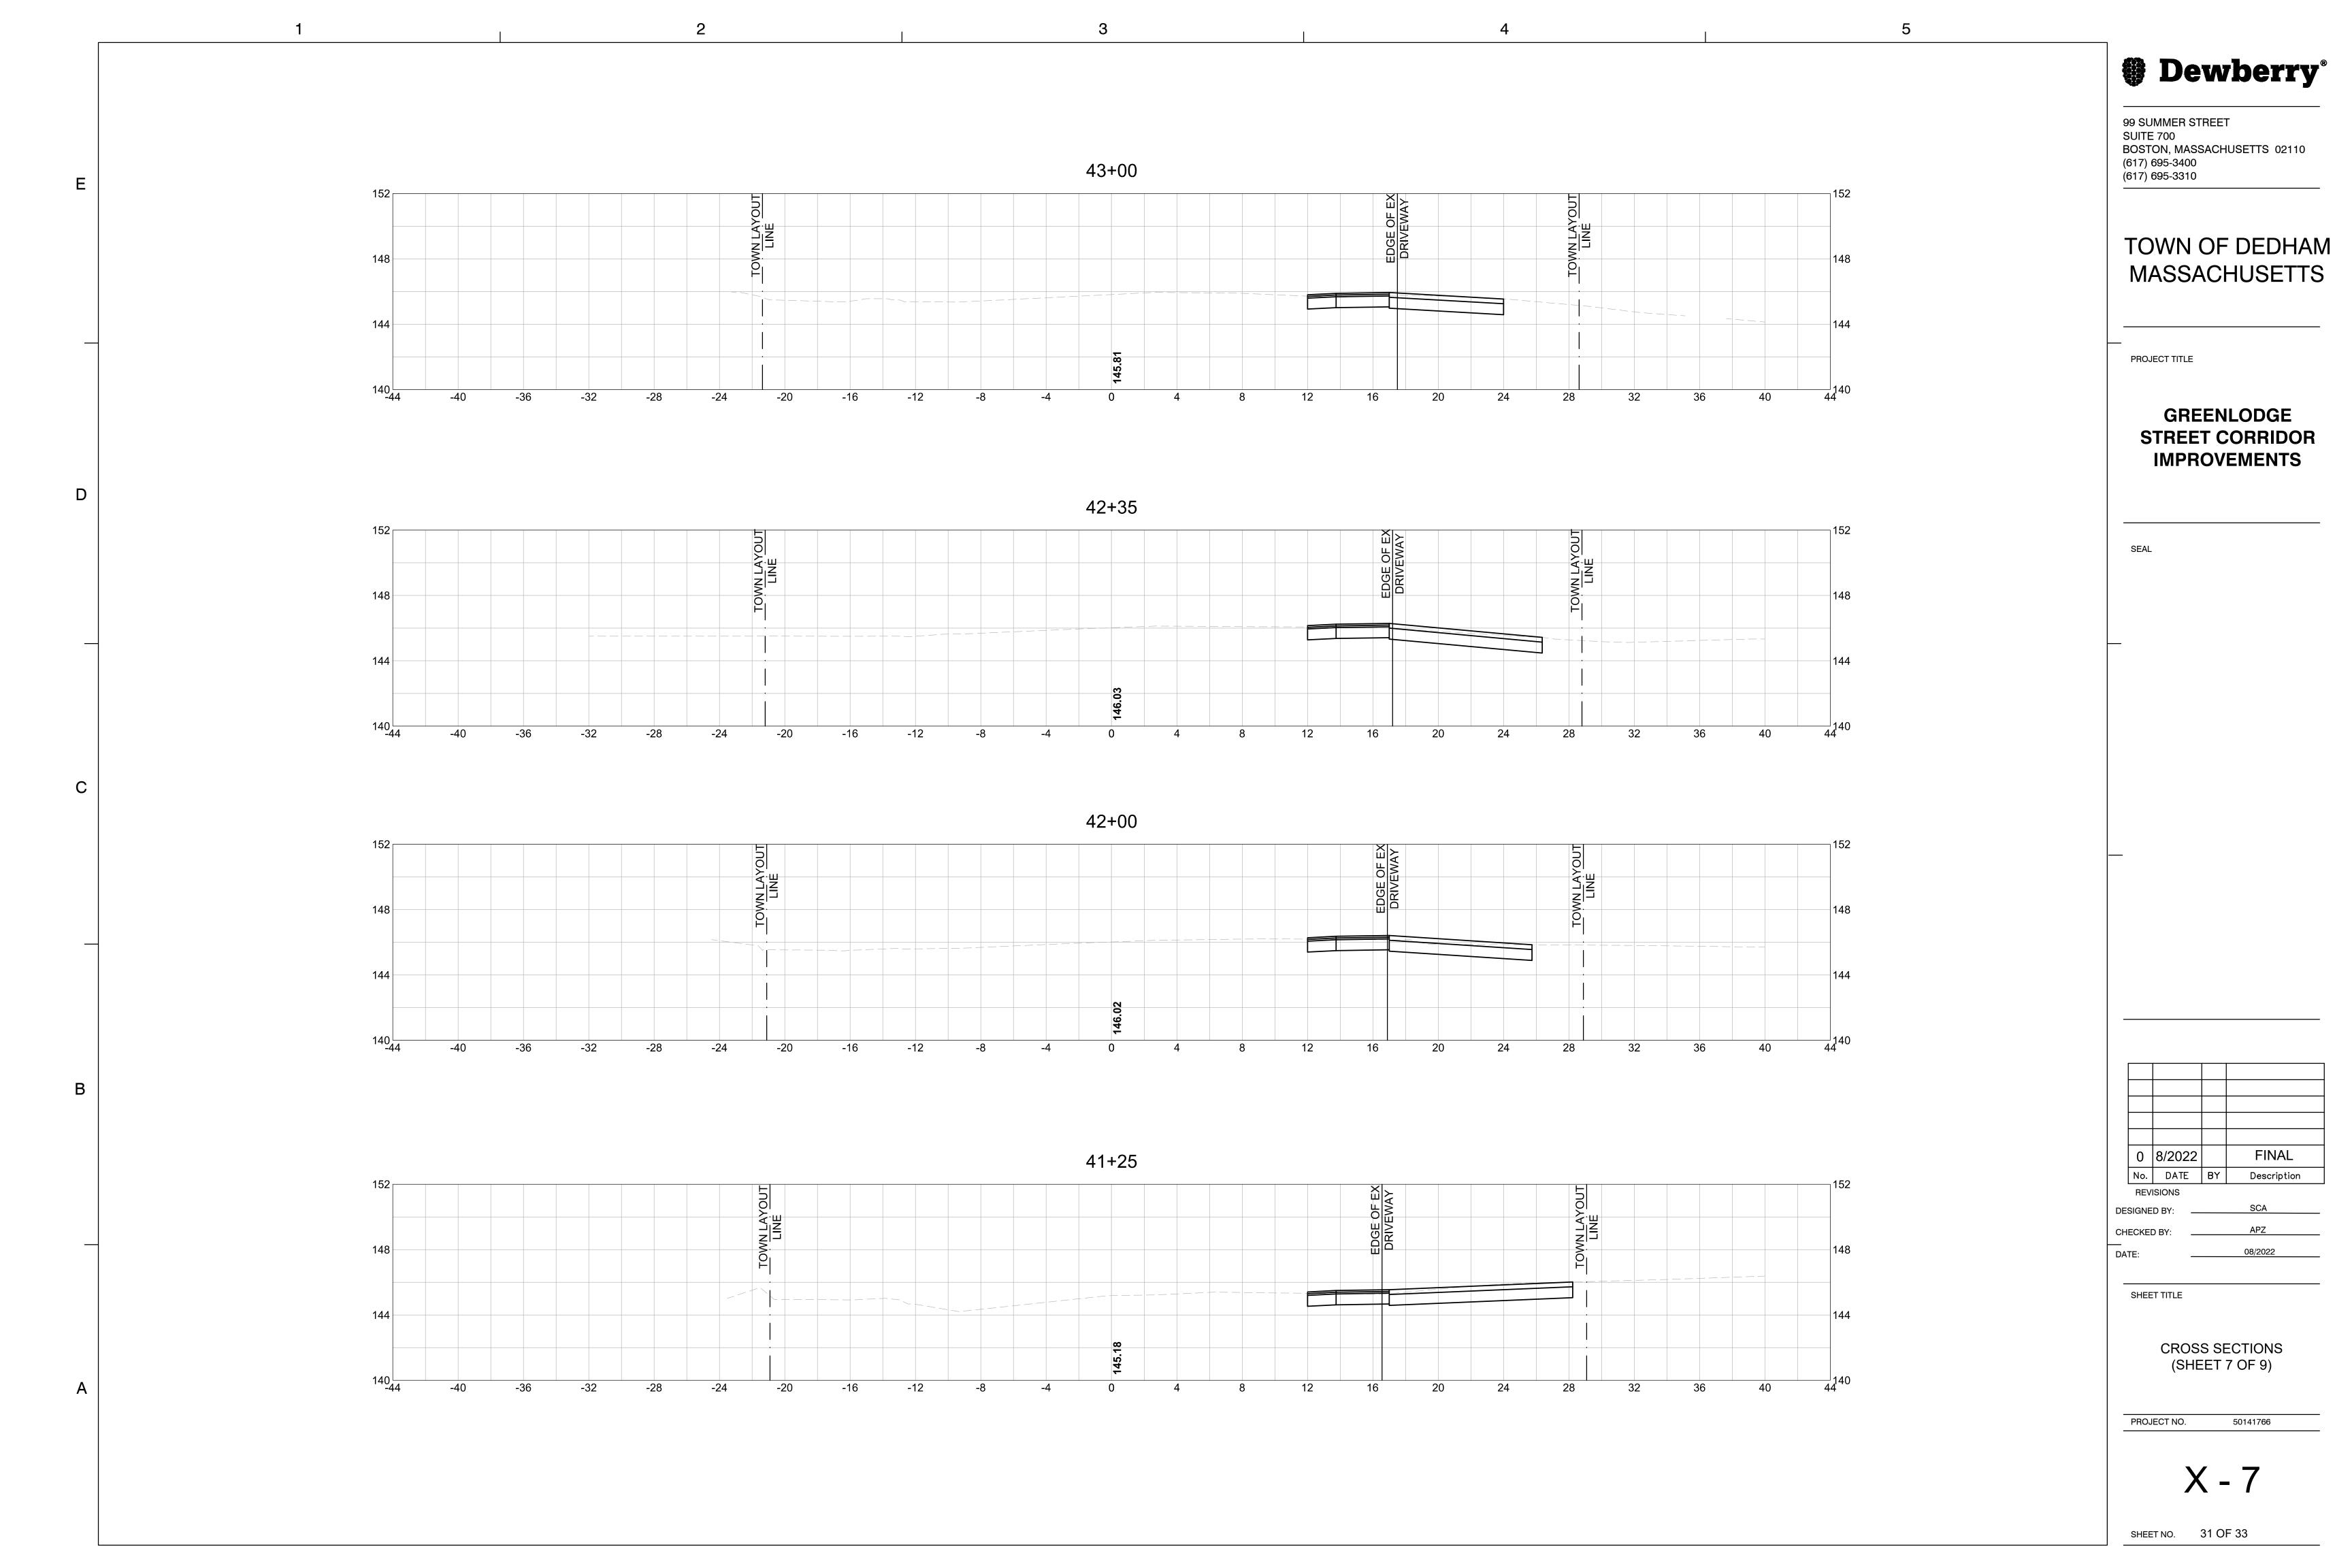
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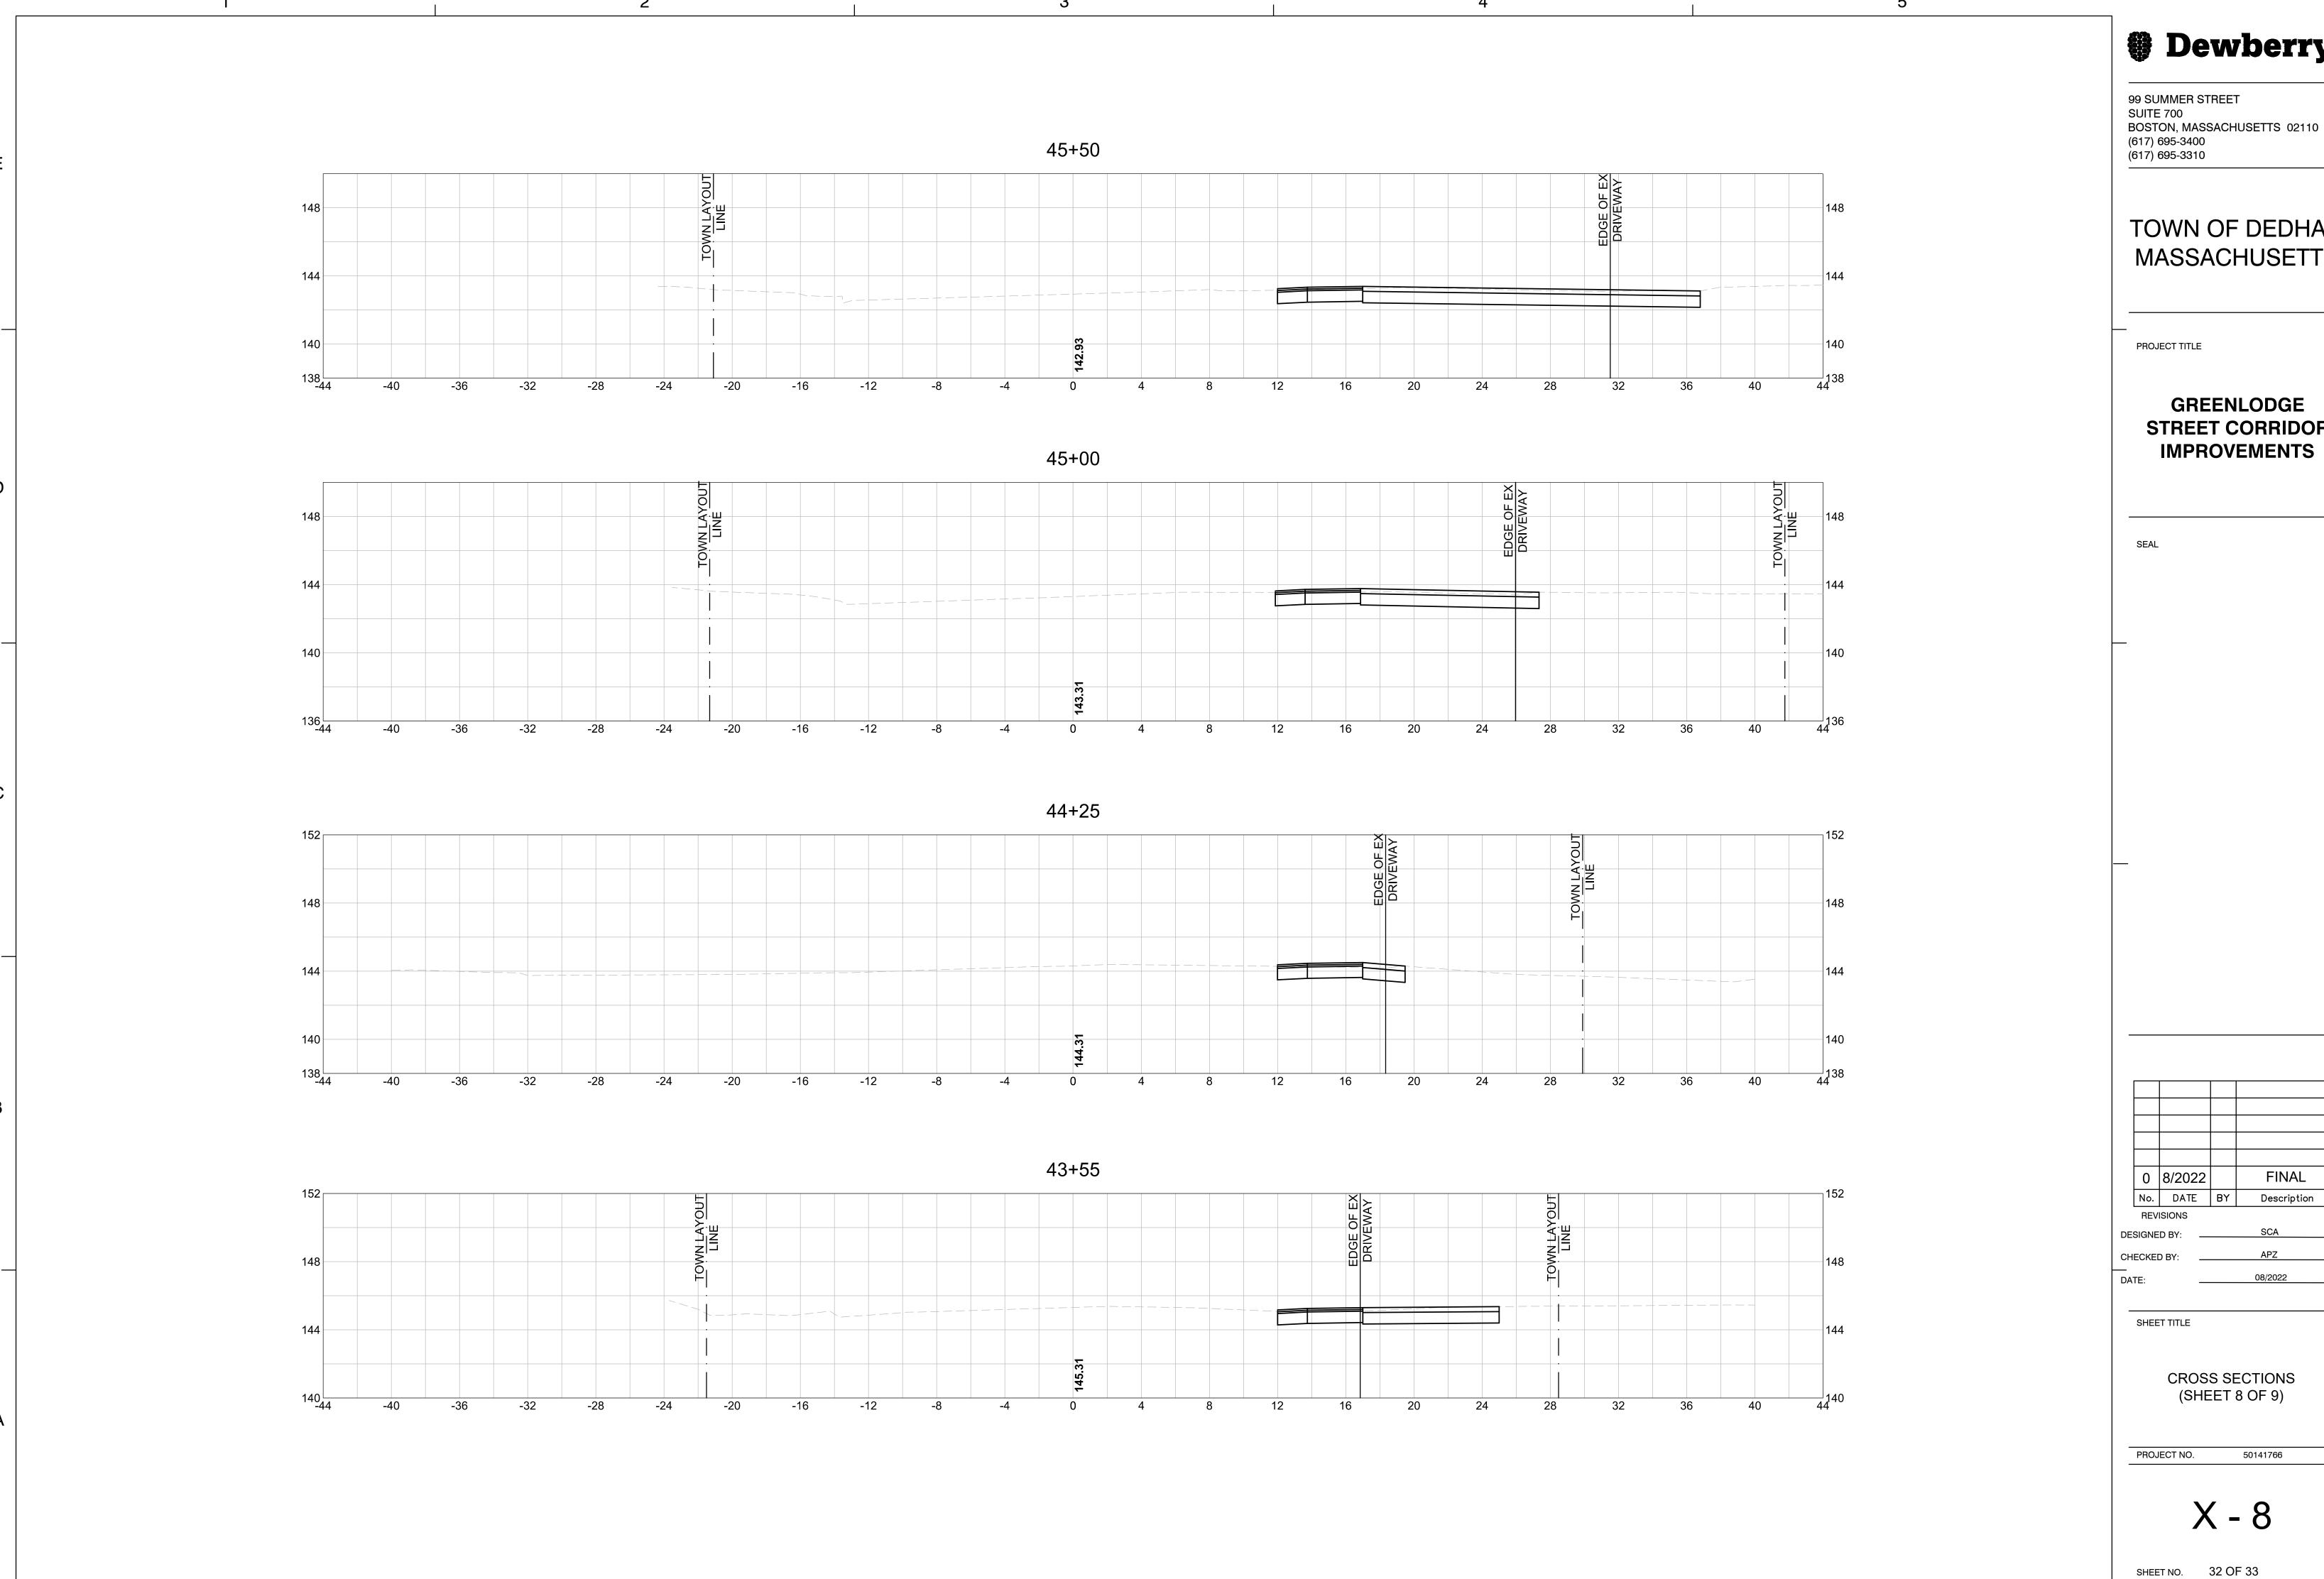
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GREENLODGE STREET CORRIDOR

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(SHEET 8 OF 9)

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